
# SITE PLAN MODIFICATION GREENVILLE BAPTIST CHURCH

674 PLEASANT STREET LEICESTER, MA 01542

FEBRUARY 14, 2020

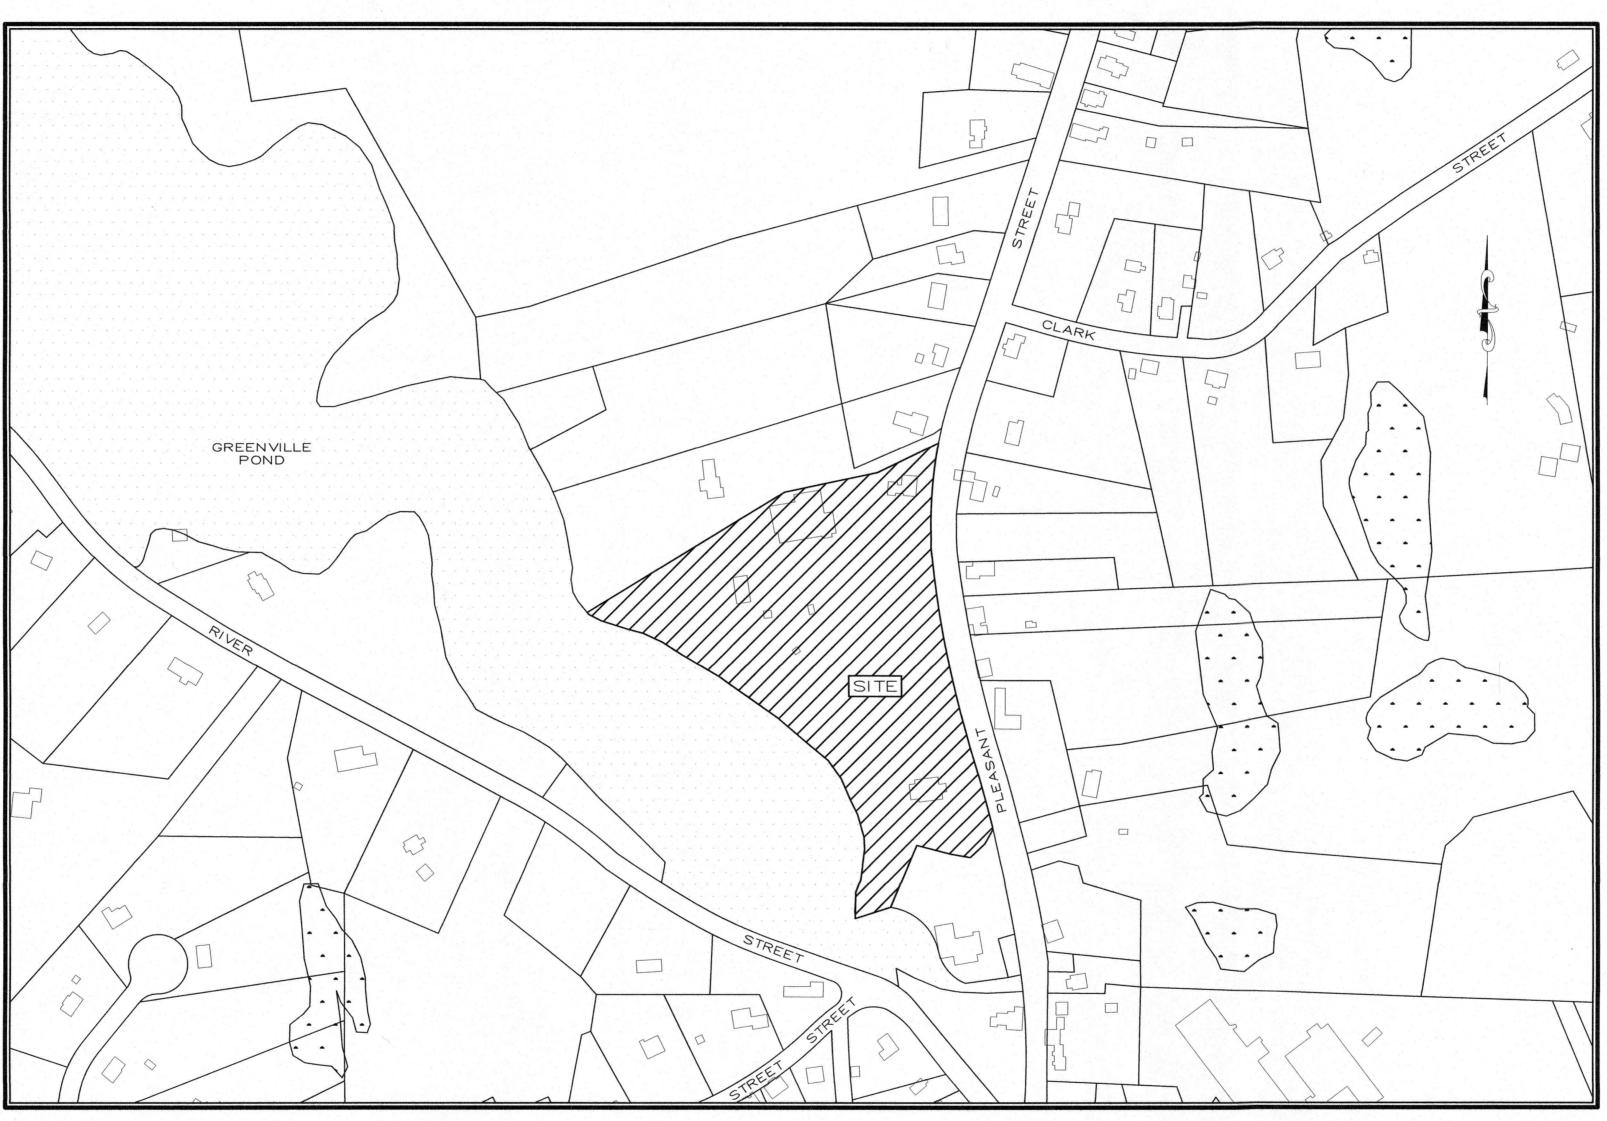

SITE LOCUS

1" = 200'

# DRAWING INDEX

TITLE SHEET C-1EXISTING CONDITIONS PLAN SITE LAYOUT PLAN SEDIMENTATION AND EROSION CONTROL PLAN PHOTOMETRIC LIGHTING PLAN C - 6CONSTRUCTION DETAILS CONSTRUCTION DETAILS

#### GENERAL SITE NOTES:

4. WETLANDS FLAGGED BY SCOTT MORIRISON OF ECOTEC, INC. ON JUNE 25, 2002


5. A PORTION OF THE SITE DOES LIE WITHIN THE SPECIAL FLOOD HAZARD AREA AS REFERENCED ON NATIONAL FLOOD INSURANCE RATE MAP NO. 25027C0783E, FOR COMMUNITY NO. AND DATED JULY 4, 2011. NO PROPOSED WORK IS LOCATED WITHIN THE


2/14/2020 1" = 200' 151-2058-K PROJ. NO.

TITLE SHEET

C-1

LEICESTER PLANNING BOARD SITE PLAN APPROVAL

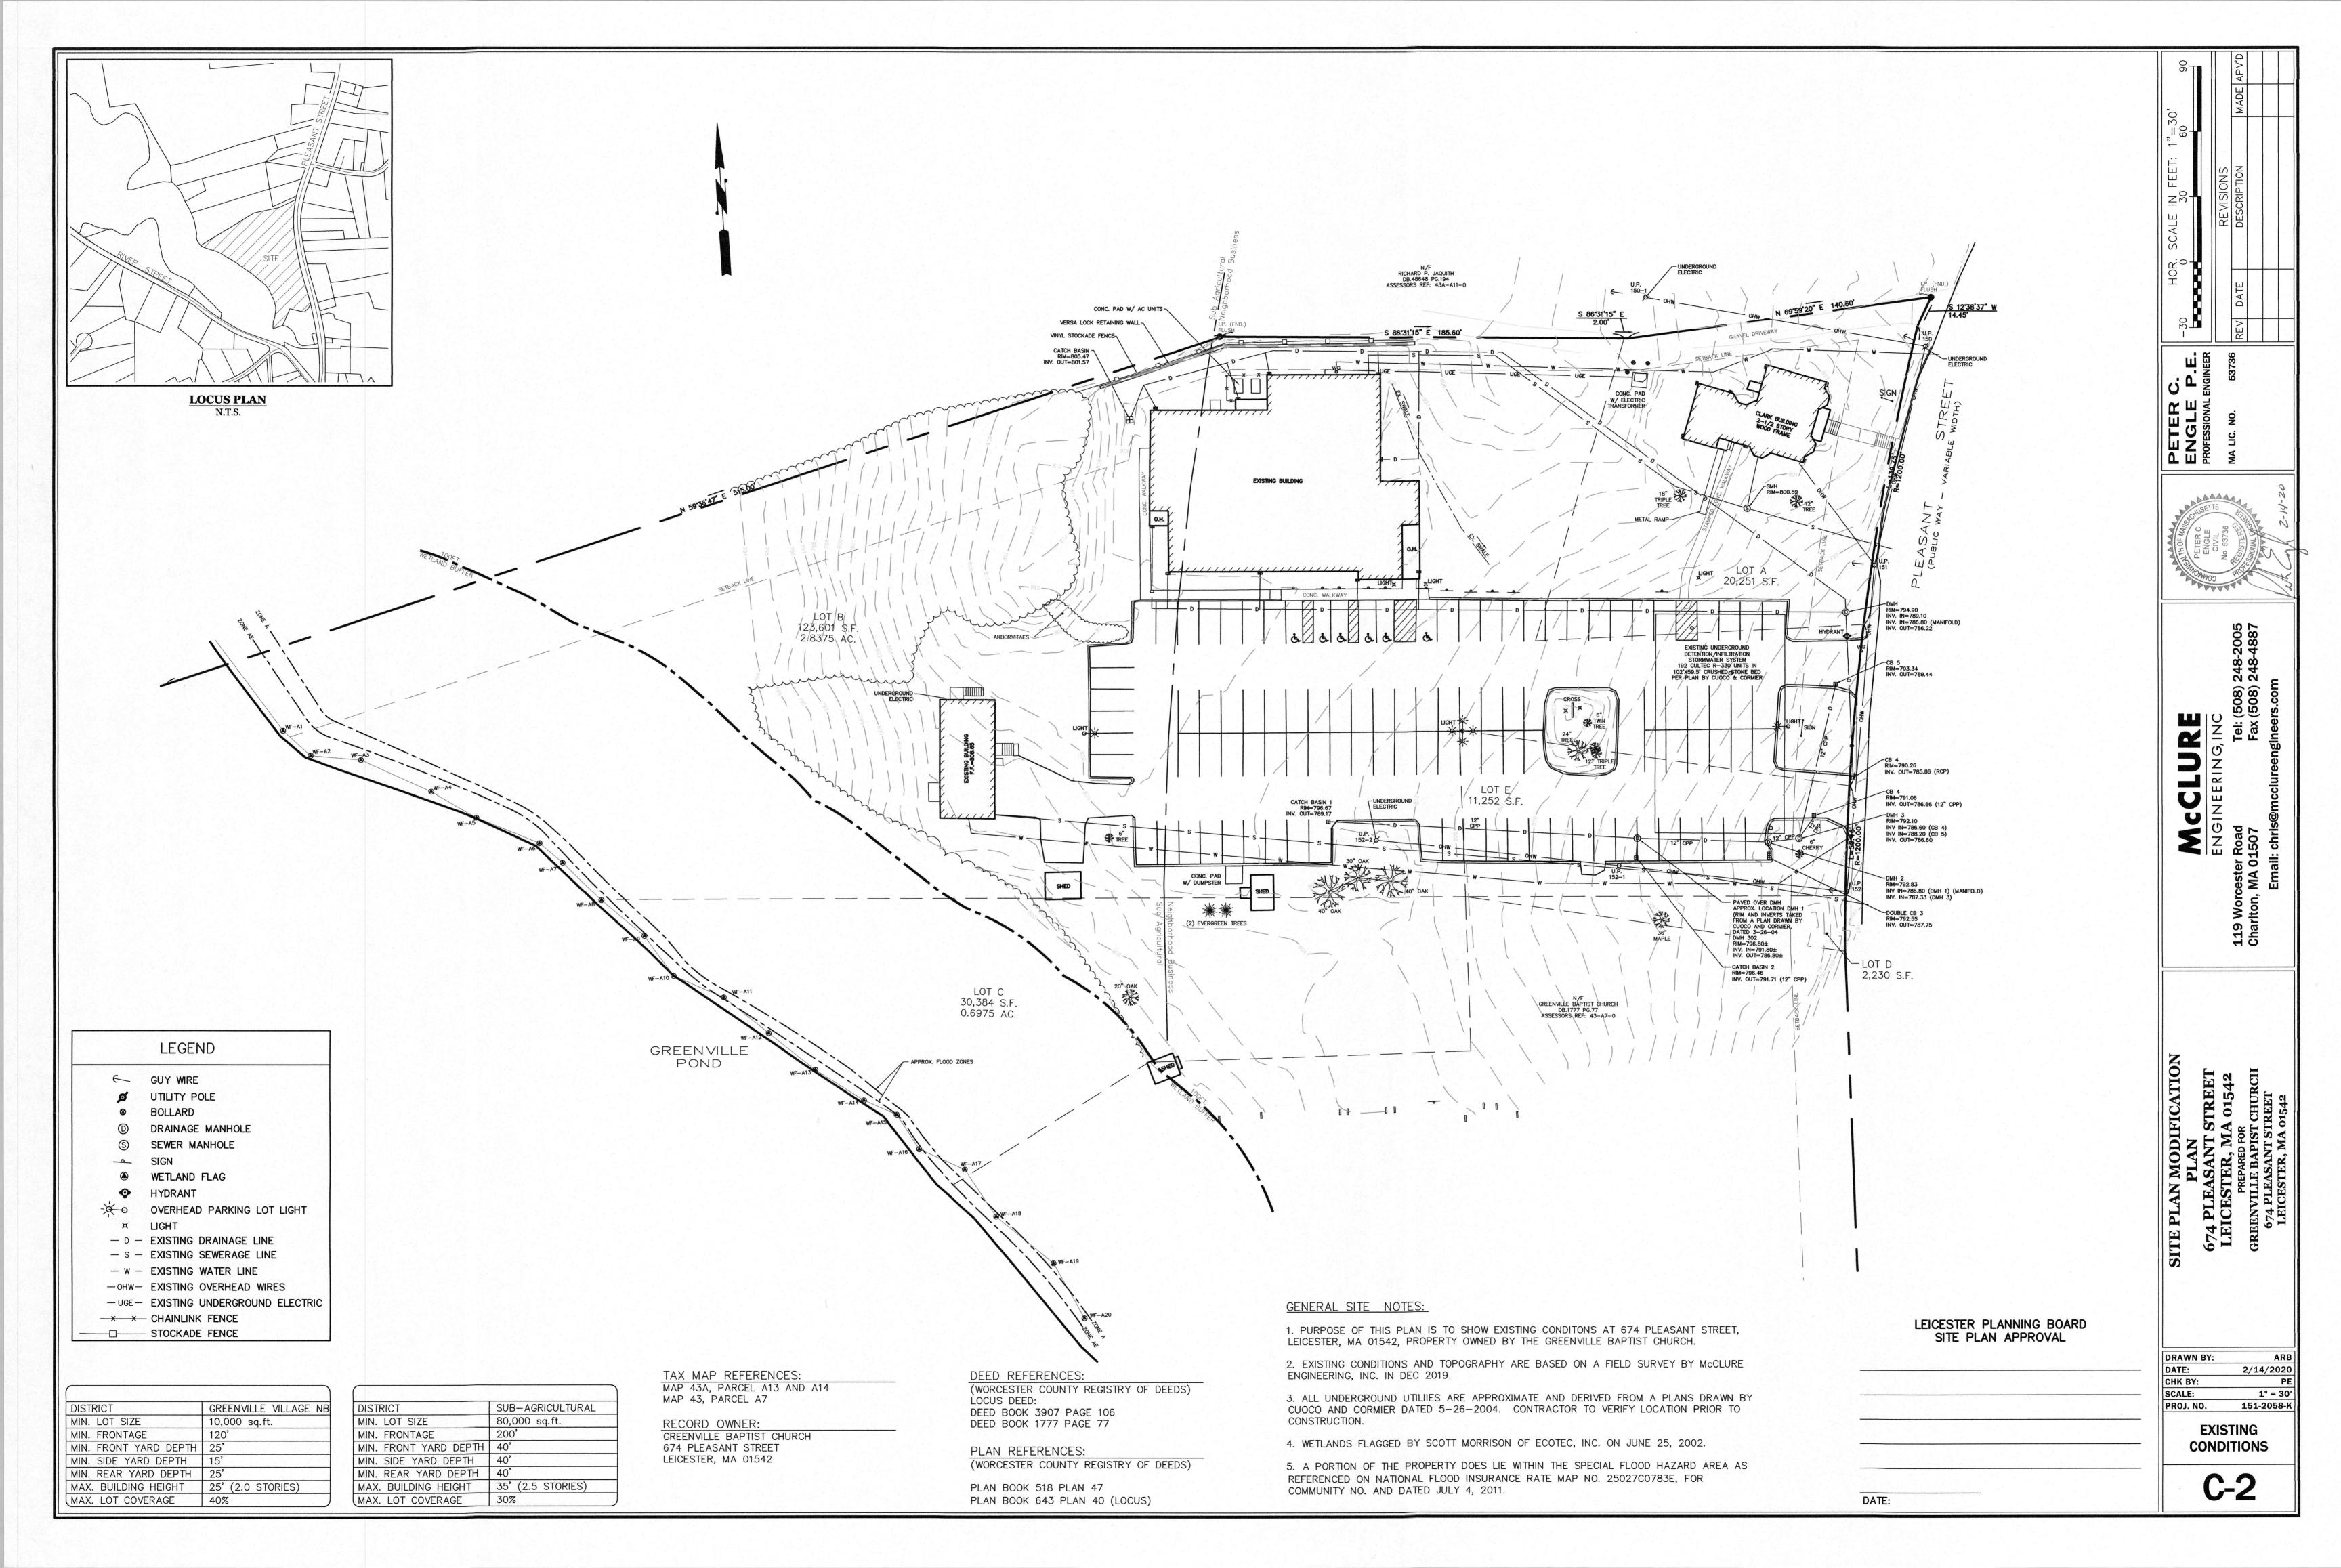

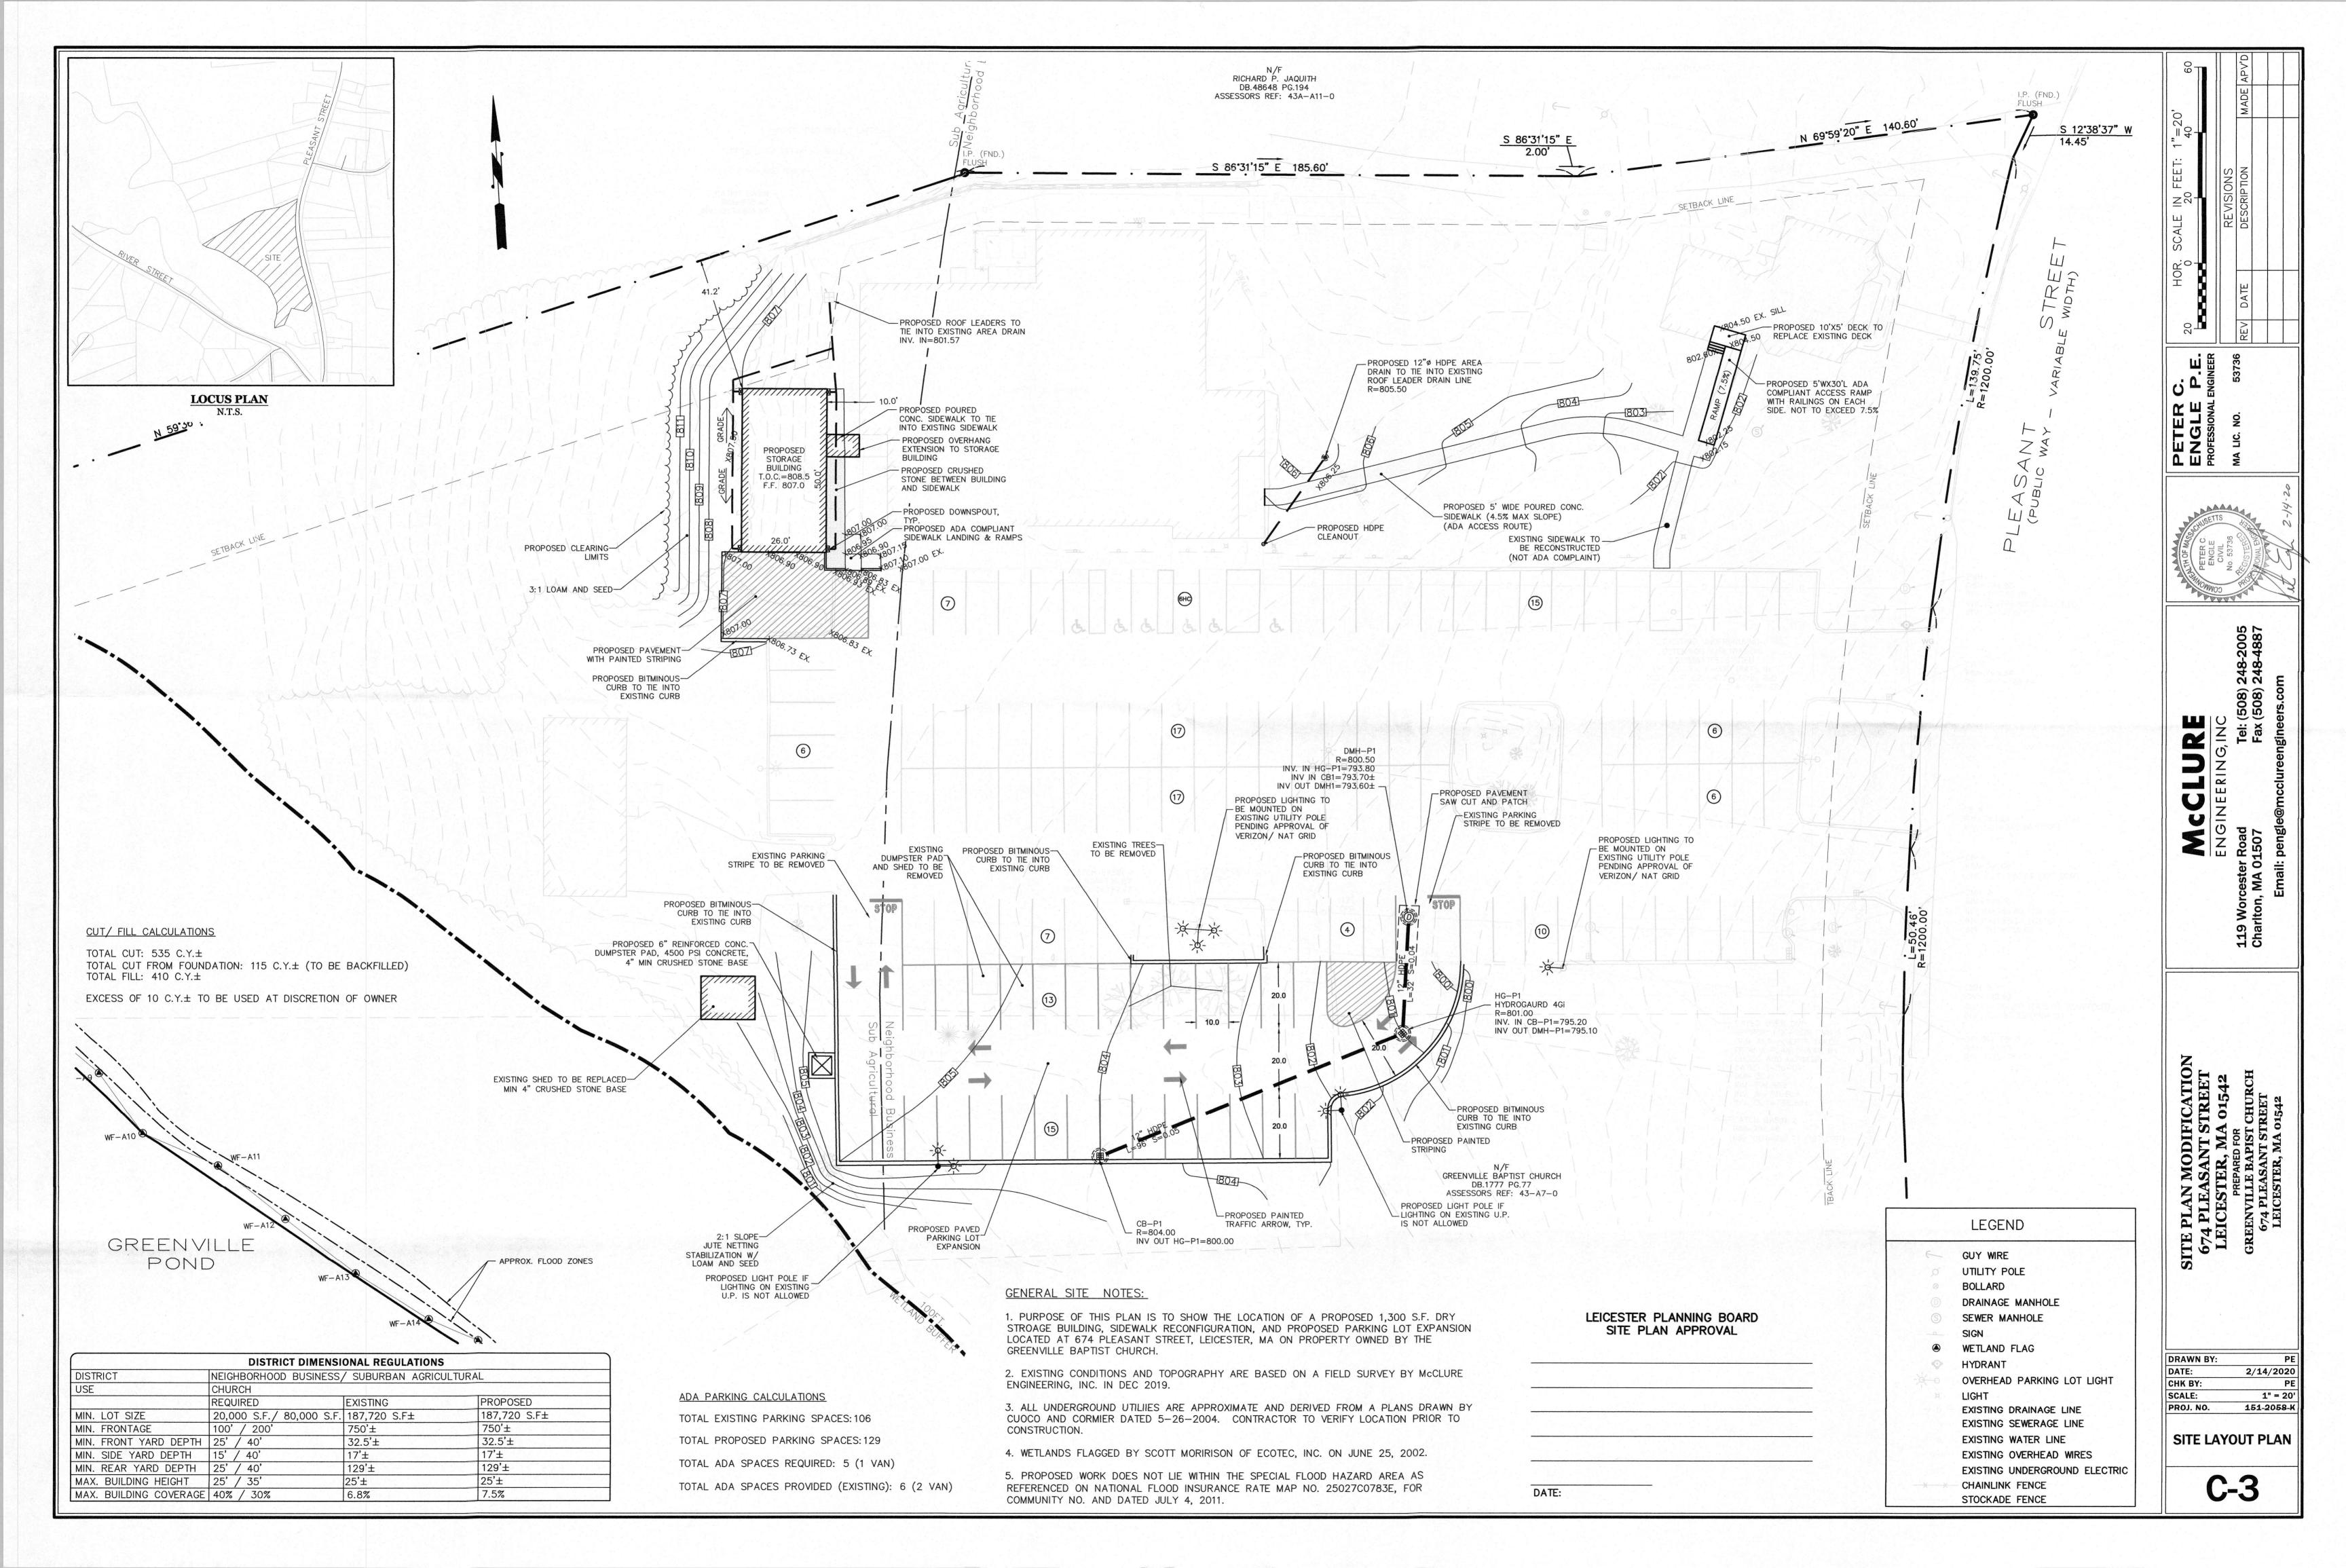

### RESPONSIBILITIES OF OWNER/PERMITEE THE OWNER / PERMITTEE SHALL: A. PROVIDE THE CONTRACTOR WITH COPIES OF LAND-USE PERMITS THAT THE OWNER HAS ACQUIRED. B. INFORM ALL PARTIES INVOLVED WITH THE PROPOSED SITE WORK OF THIS PLAN'S OBJECTIVES AND REQUIREMENTS. RESPONSIBILITIES OF CONTRACTOR THE CONTRACTOR IS RESPONSIBLE FOR PREVENTING EROSION OF THE SITE AND FOR PROTECTING ADJACENT PROPERTIES, STORM SEWERS AND WATERWAYS FROM SEDIMENTATION. THE CONTRACTOR SHALL: A. INSTALL, MONITOR, AND MAINTAIN ALL OF THE SOIL EROSION AND SEDIMENT CONTROL MEASURES AS SHOWN ON B. COMPLY WITH ALL PERMIT REQUIREMENTS. PRE-CONSTRUCTION CONFERENCE THE PERMITEE, OWNER-OF-RECORD, CONTRACTOR, ENGINEER, AND THE TOWN SHALL HOLD A "PRE-CONSTRUCTION" CONFERENCE REVIEW THE PROPOSED SOIL EROSION AND SEDIMENT CONTROL MEASURES. GENERAL CONTROLS CLEANING OF STORMWATER STRUCTURES: CLEAN ALL STORMWATER STRUCTURES INCLUDING, BUT NOT LIMITED TO, PIPES, SWALES, SUBSURFACE RETENTION BASINS, SEDIMENT TRAPS, AND RIPRAP APRONS OF SEDIMENT UPON COMPLETION OF THE PROJECT. PLACE CLEAN WASHED STONE AT THE SITE ENTRANCES TO THE LENGTH, WIDTH AND DEPTH INDICATED ON THE PLANS AND DETAILS TO HELP REMOVE MUD AND/OR CLODS OF SOIL FROM CONSTRUCTION VEHICLES EXITING FROM THE SITE. ADD ADDITIONAL STONE AS NECESSARY TO MAINTAIN ADEQUATE SERVICEABILITY. THE CONTRACTOR SHALL SWEEP PAVED ROADWAYS ADJACENT TO THE SITE ON A ROUTINE BASIS TO PREVENT TRACKING OF MUD ONTO PUBLIC ROADWAYS AND WASHING OF MUD INTO WATERWAYS. IF THE CONTRACTOR'S SCHEDULE FOR CLEANING THE PAVEMENT IS FOUND TO BE INADEQUATE BY THE OWNER, OWNER'S REPRESENTATIVE, OR TOWN, THE CONTRACTOR SHALL INCREASE THE FREQUENCY AT NO ADDITIONAL COST TO THE OWNER. THE CONTRACTOR SHALL PROVIDE AN ADEQUATE NUMBER OF COVERED WASTE CONTAINERS TO ENSURE THAT NO LITTER, DEBRIS, BUILDING MATERIALS, OR SIMILAR MATERIALS ARE DISCHARGED TO WETLANDS OR WATERCOURSES. THE CONTRACTOR SHALL INSTRUCT SUBCONTRACTORS TO USE THE CONTAINERS FOR WASTE MATERIAL. THE

DESCRIPTION AND MAINTENANCE OF EROSION CONTROL MEASURES

LEVELS HAVE REACHED 1/4 OF THE EFFECTIVE HEIGHT. REPAIR AND/OR REPLACE STRAW WATTLES

COMPLETELY SURROUND TEMPORARY MATERIAL STOCKPILES WITH STRAW WATTLES TO PREVENT

TAKE PRECAUTIONS TO PREVENT DUST FROM BECOMING A NUISANCE TO ABUTTING PROPERTY OWNERS.

DISTURBED PORTIONS OF THE SITE WHERE CONSTRUCTION ACTIVITIES PERMANENTLY CEASE SHALL BE STABILIZED WITH PERMANENT SEED NO LATER THAN 14 DAYS AFTER THE LAST CONSTRUCTION ACTIVITY.

THE CONTRACTOR SHALL BE RESPONSIBLE FOR ALL LANDSCAPED AREAS. IF TOPSOIL, SEE, AND/OR MULCH

1. AT NO TIME SHALL EXCAVATION "DEWATERING BE DIRECTLY DISCHARGED TO: CATCH BASIN, DRAIN PIPE

TRENCH & EXCAVATION DE-WATERING WASTEWATER SHALL BE DISCHARGED THROUGH AN "ULTRA

3. DE-WATERING DISCHARGES SHALL BE DIRECTED TO ON-SITE SEDIMENT CONTROL SYSTEMS AND/OR

PIPESOCK" OR EQUIVALENT SEDIMENT/OIL FILTER TRAP WITH 12" DEPTH GRAVEL FILTER BERM.

BROOM OFF PAVEMENT AREAS ADJOINING THE EXCAVATION ON A DAILY BASIS. COVER AND/OR KEEP MOIST ALL EARTH STOCKPILES AT ALL TIMES. USE CALCIUM CHLORIDE TO CONTROL DUST OVER CERTAIN AREAS OF THE SITE AS NEEDED AND/OR AS DIRECTED BY THE ENGINEER. CALCIUM CHLORIDE SHALL CONFORM TO ASTM D-98, TYPE I. THE CONTRACTOR SHALL MAINTAIN AND INSPECT, ON A DAILY BASIS, THE ADEQUACY OF DUST

INSTALL STRAW WATTLES AT VARIOUS LOCATIONS AS SHOWN ON THE PLANS AND DETAILS. EMBED THE STRAW

INSTALL INLET PROTECTION/ SILT SACKS AT VARIOUS EXISTING CATCH BASIN LOCATIONS AS SHOWN ON THE PLAN

WATTLES INTO THE GROUND AND FIRMLY ANCHOR IT AS SHOWN IN THE DETAILS. REMOVE SEDIMENT ONCE

CONTAINERS SHALL BE PROMPTLY EMPTIED WHEN FULL.

TEMPORARY STABILIZATION MEASURES

STOCKPILING OR STORAGE OF EXCAVATED MATERIALS:

PERMANENT STABILIZATION MEASURES

WETLAND, STREAM, OR FLOOD PLAIN AREA.

DRAINAGE SWALES.

CONTROL MEASURES AND CORRECT ANY DEFICIENCIES IMMEDIATELY.


IS WASHED AWAY BY RAINFALL, THE CONTRACTOR SHALL RESTORE THE AREA.

IMMEDIATELY IF DAMAGED OR DETERIORATED.

TRANSPORTATION OF SEDIMENT.

STRAW WATTLE TUBES:

AND DETAILS.

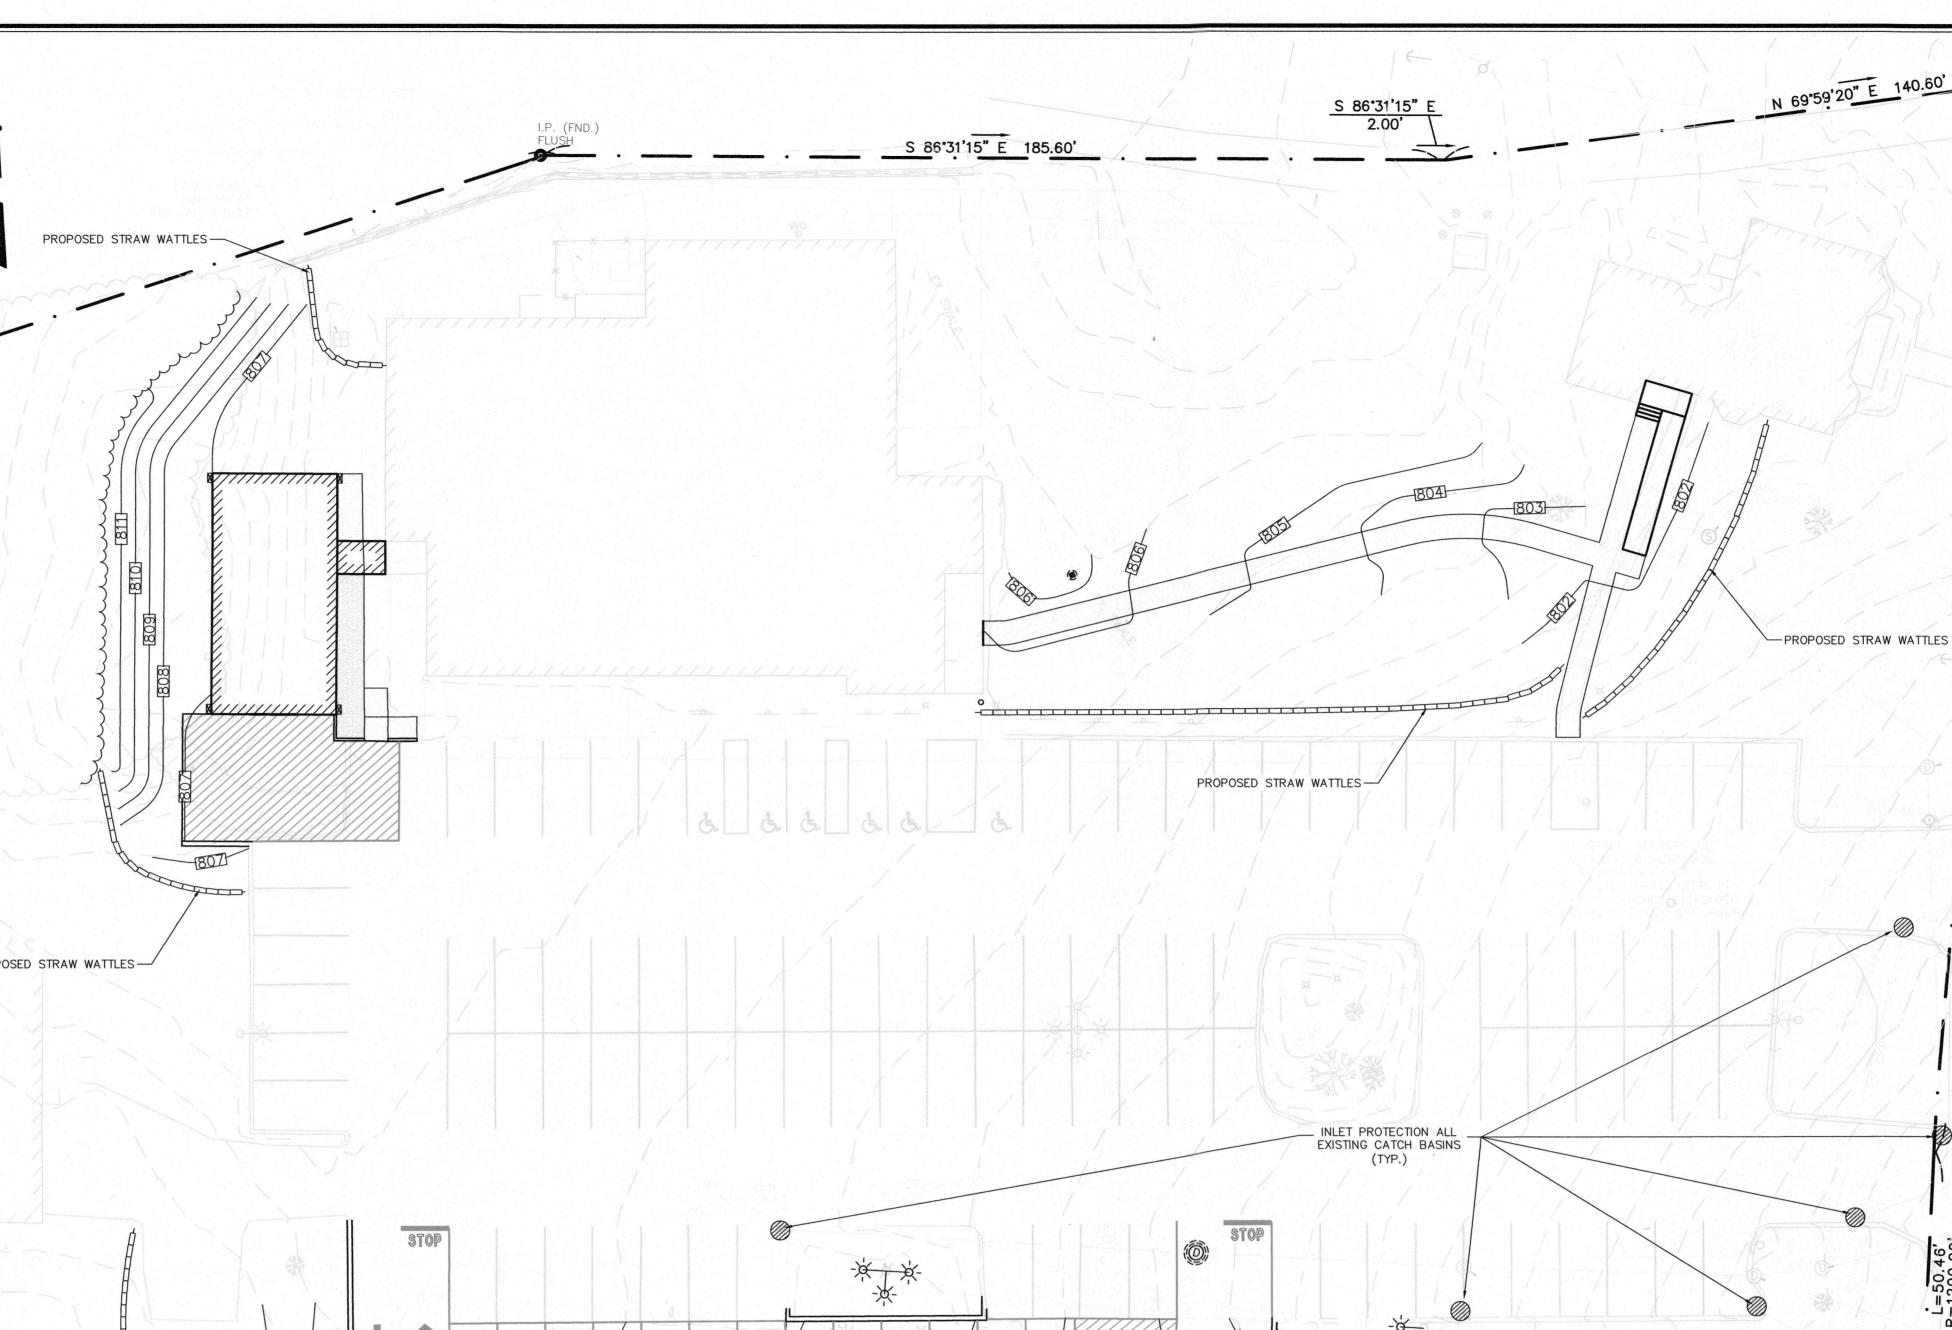

GENERAL CONDITIONS 1. IF EROSION CONTROL MEASURES ARE DAMAGED BY CONSTRUCTION VEHICLES, ACTS OF VANDALISM, OR SEVERE WEATHER CONDITIONS, THE CONTRACTOR SHALL IMMEDIATELY REMOVE SEDIMENT IN THE VICINITY OF THE EROSION CONTROL MEASURES AND REPAIR THESE MEASURES TO A FUNCTIONAL CONDITION. 2. IF, DURING OR AFTER CONSTRUCTION, IT BECOMES APPARENT THAT EXISTING EROSION CONTROL MEASURES ARE INCAPABLE OF CONTROLLING EROSION. THE ENGINEER OR THE TOWN MAY REQUIRE ADDITIONAL CONTROL MEASURES, INCLUDING BUT NOT LIMITED TO: ADDITIONAL STRAW WATTLES, HAYBALES, SILT FENCE, SEDIMENT BASINS, MECHANICALLY ANCHORED MULCH, OR ENHANCED DEWATERING FILTRATION. 3. NO CONSTRUCTION SHALL PROCEED UNTIL A WRITTEN PROPOSAL OF METHODS TO PREVENT CONSTRUCTION DEBRIS, PAINT, OR OTHER SUCH CONTAMINATED MATERIALS FROM ENTERING A STORM SEWER, THE WETLAND, OR WATERCOURSE HAS BEEN SUBMITTED BY THE CONTRACTOR TO THE OWNER, APPROVED BY THE OWNER AND SUCH METHODS HAVE BEEN IMPLEMENTED AS THE OWNER DIRECTS. THESE MATERIALS SHALL BE COLLECTED AND DISPOSED OF IN AN ENVIRONMENTALLY SAFE MANNER IN ACCORDANCE WITH ALL APPLICABLE FEDERAL AND STATE LAWS AND REGULATIONS. THE OWNER MAY ORDER THE CONTRACTOR TO CEASE SUCH ACTIVITY TEMPORARILY IF, IN THE JUDGMENT OF THE OWNER, WIND OR STORM CONDITIONS THREATEN TO CAUSE THE DEPOSIT OF SUCH MATERIAL IN A WATERWAY. 4. ALL TEMPORARY FILL SHALL BE STABILIZED DURING USE TO PREVENT EROSION AND SHALL BE SUITABLY CONTAINED TO PREVENT SEDIMENT OF OTHER PARTICULATE MATTER FROM REENTERING A WETLAND OR WATERCOURSE. ALL AREAS AFFECTED BY TEMPORARY FILLS MUST BE RESTORED TO THEIR ORIGINAL CONTOURS OR AS DIRECTED BY THE OWNER, AND REVEGETATED. THE AREA EXTENT OF TEMPORARY FILL OR EXCAVATION SHALL BE CONFINED TO THAT AREA NECESSARY TO PERFORM THE WORK, AS APPROVED BY THE DUMPING OF OIL, CHEMICALS OR OTHER DELETERIOUS MATERIALS ON THE GROUND IS FORBIDDEN. THE CONTRACTOR SHALL PROVIDE A MEANS OF CATCHING, RETAINING, AND PROPERLY DISPOSING OF DRAINED OIL, REMOVED OIL FILTERS, OR OTHER DELETERIOUS MATERIAL. ALL SPILLS OF SUCH MATERIALS SHALL BE REPORTED IMMEDIATELY BY THE CONTRACTOR TO APPROPRIATE TOWN AND STATE AGENCIES.

SEQUENCE OF CONSTRUCTION
THE FOLLOWING NARRATIVE DESCRIBES THE PLANNED CONSTRUCTION SEQUENCE WITH AN EMPHASIS ON THE TIMING AND SEQUENCE OF EROSION/SEDIMENTATION CONTROL MEASURES:

THE FOLLOWING CONSTRUCTION SEQUENCE WILL BE REQUIRED TO INSURE THE EFFECTIVENESS OF THE EROSION/SEDIMENT CONTROL MEASURES IS OPTIMIZED. INSTALL EROSION CONTROL BARRIERS ON THE ENTIRE SITE

ENGINEERING INSPECTION WILL BE CONDUCTED AFTER INSTALLATION OF EROSION CONTROL BARRIERS ARE INSTALLED. GENERAL CONTRACTOR SHALL SCHEDULE AND CONDUCT STORM WATER PRE—CONSTRUCTION MEETING WITH ENGINEER AND ALL GROUND—DISTURBING CONTRACTORS BEFORE PROCEEDING WITH CONSTRUCTION. PREPARE TEMPORARY PARKING AND STORAGE AREA UPON IMPLEMENTATION AND INSTALLATION

F THE FOLLOWING AREAS: PARKING, LAY DOWN, PORTA POTTY, MATERIAL STORAGE CONTAINERS, C., DENOTE THEM ON THE SITE MAPS IMMEDIATELY AND NOTE ANY CHANGES IN THE LOCATIONS S THEY OCCUR THROUGHOUT THE CONSTRUCTION PROCESS.

BEGIN CLEARING AND GRUBBING REMAINDER OF THE SITE. INSTALL TEMPORARY DIVERSION DITCHES AND CHECK DAMS AS NECESSARY.

START INSTALLATION OF UNDERGROUND UTILITES (DRAINAGE, SEWER, WATER, ELECTRIC, ETC.) START INSTALLATION OF SITE IMPROVEMENTS (BUILDING, FENCING, ETC.) AND FINAL GRADING. TEMPORARILY SEED, THROUGHOUT CONSTRUCTION, DENUDED AREAS THAT WILL BE INACTIVE FOR 15 DAYS OR MORE. PERMANENTLY STABILIZE AREAS TO BE VEGETATED AS THEY ARE

FINAL PHASE

1. PERMANENTLY STABILIZE ANY REMAINING EXPOSED AREAS

TEMPORARY DRAINAGE DITCHES TO BE REMOVED AND STABILIZED.

ONCE ENTIRE SITE IS STABILIZED, CALL FOR FINAL INSPECTION FROM SITE MONITOR.

ONCE CONSTRUCTION IS COMPLETED, ALL DISTURBED AREAS ARE TO BE STABILIZED WITH LOAM AND SEED UNLESS OTHERWISE SPECIFIED. . INSPECTIONS WILL BE CONDUCTED WEEKLY AND AFTER 0.25 INCH RAIN EVENTS. COPIES OF WEEKLY REPORTS AND RAIN EVENT REPORTS SHALL BE KEPT ON FILE AND MADE AVAILABLE UPON

REQUEST AT THE TOWN OR TOWNS CONSULTANT. . EXTRA EROSION CONTROL MATERIALS (WATTLES) EQUAL TO 100 LF SHALL BE KEPT ON SITE FOR EMERGENCY REPAIRS. THESE MATERIALS SHALL BE KEPT COVERED.

PROJ. NO. 151-2058-K SEDIMENT AND EROSION SONTROL

2/14/2020

1" = 20'

DRAWN BY

SCALE:

PROPOSED STRAW WATTLES-2:1 SLOPE--PROPOSED STRAW WATTLES JUTE NETTING STABILIZATION W/ LOAM AND SEED BEGIN SITE ROUGH GRADING. LEICESTER PLANNING BOARD SITE PLAN APPROVAL

TOTAL LAND DISTURBANCE: 26,500 S.F.±

## GENERAL SITE NOTES:

. EXISTING CONDITIONS AND TOPOGRAPHY ARE BASED ON A FIELD SURVEY BY McCLURE ENGINEERING, INC. IN DEC 2019.

INSPECTIONS: EROSION CONTROL SHOULD BE INSPECTED DAILY OR AFTER A LEGITIMATE STORM EVENT.

2. ALL UNDERGROUND UTILIIES ARE APPROXIMATE AND DERIVED FROM A PLANS DRAWN BY CUORCO AND CORMIER DATED 5-26-2004. CONTRACTOR TO VERIFY LOCATION PRIOR TO CONSTRUCTION.

3. WETLANDS FLAGGED BY SCOTT MORIRISON OF ECOTEC, INC. ON JUNE 25, 2002

3. PROPERTY DOES, WORK DOES NOT LIE WITHIN THE SPECIAL FLOOD HAZARD AREA AS REFERENCED ON NATIONAL FLOOD INSURANCE RATE MAP NO. 25027C0783E, FOR COMMUNITY NO. AND DATED JULY 4, 2011.




SITE PLAN MODIFICAT
674 PLEASANT STREF
LEICESTER, MA 0154
PREPARED FOR
GREENVILLE BAPIST CHURG
674 PLEASANT STREET

PETER ENGLE

DRAWN BY: PE
DATE: 2/14/2020
CHK BY: PE
SCALE: 1" = 20'
PROJ. NO. 151-2058-K

PHOTOMETRIC LIGHTING PLAN

**C-5** 

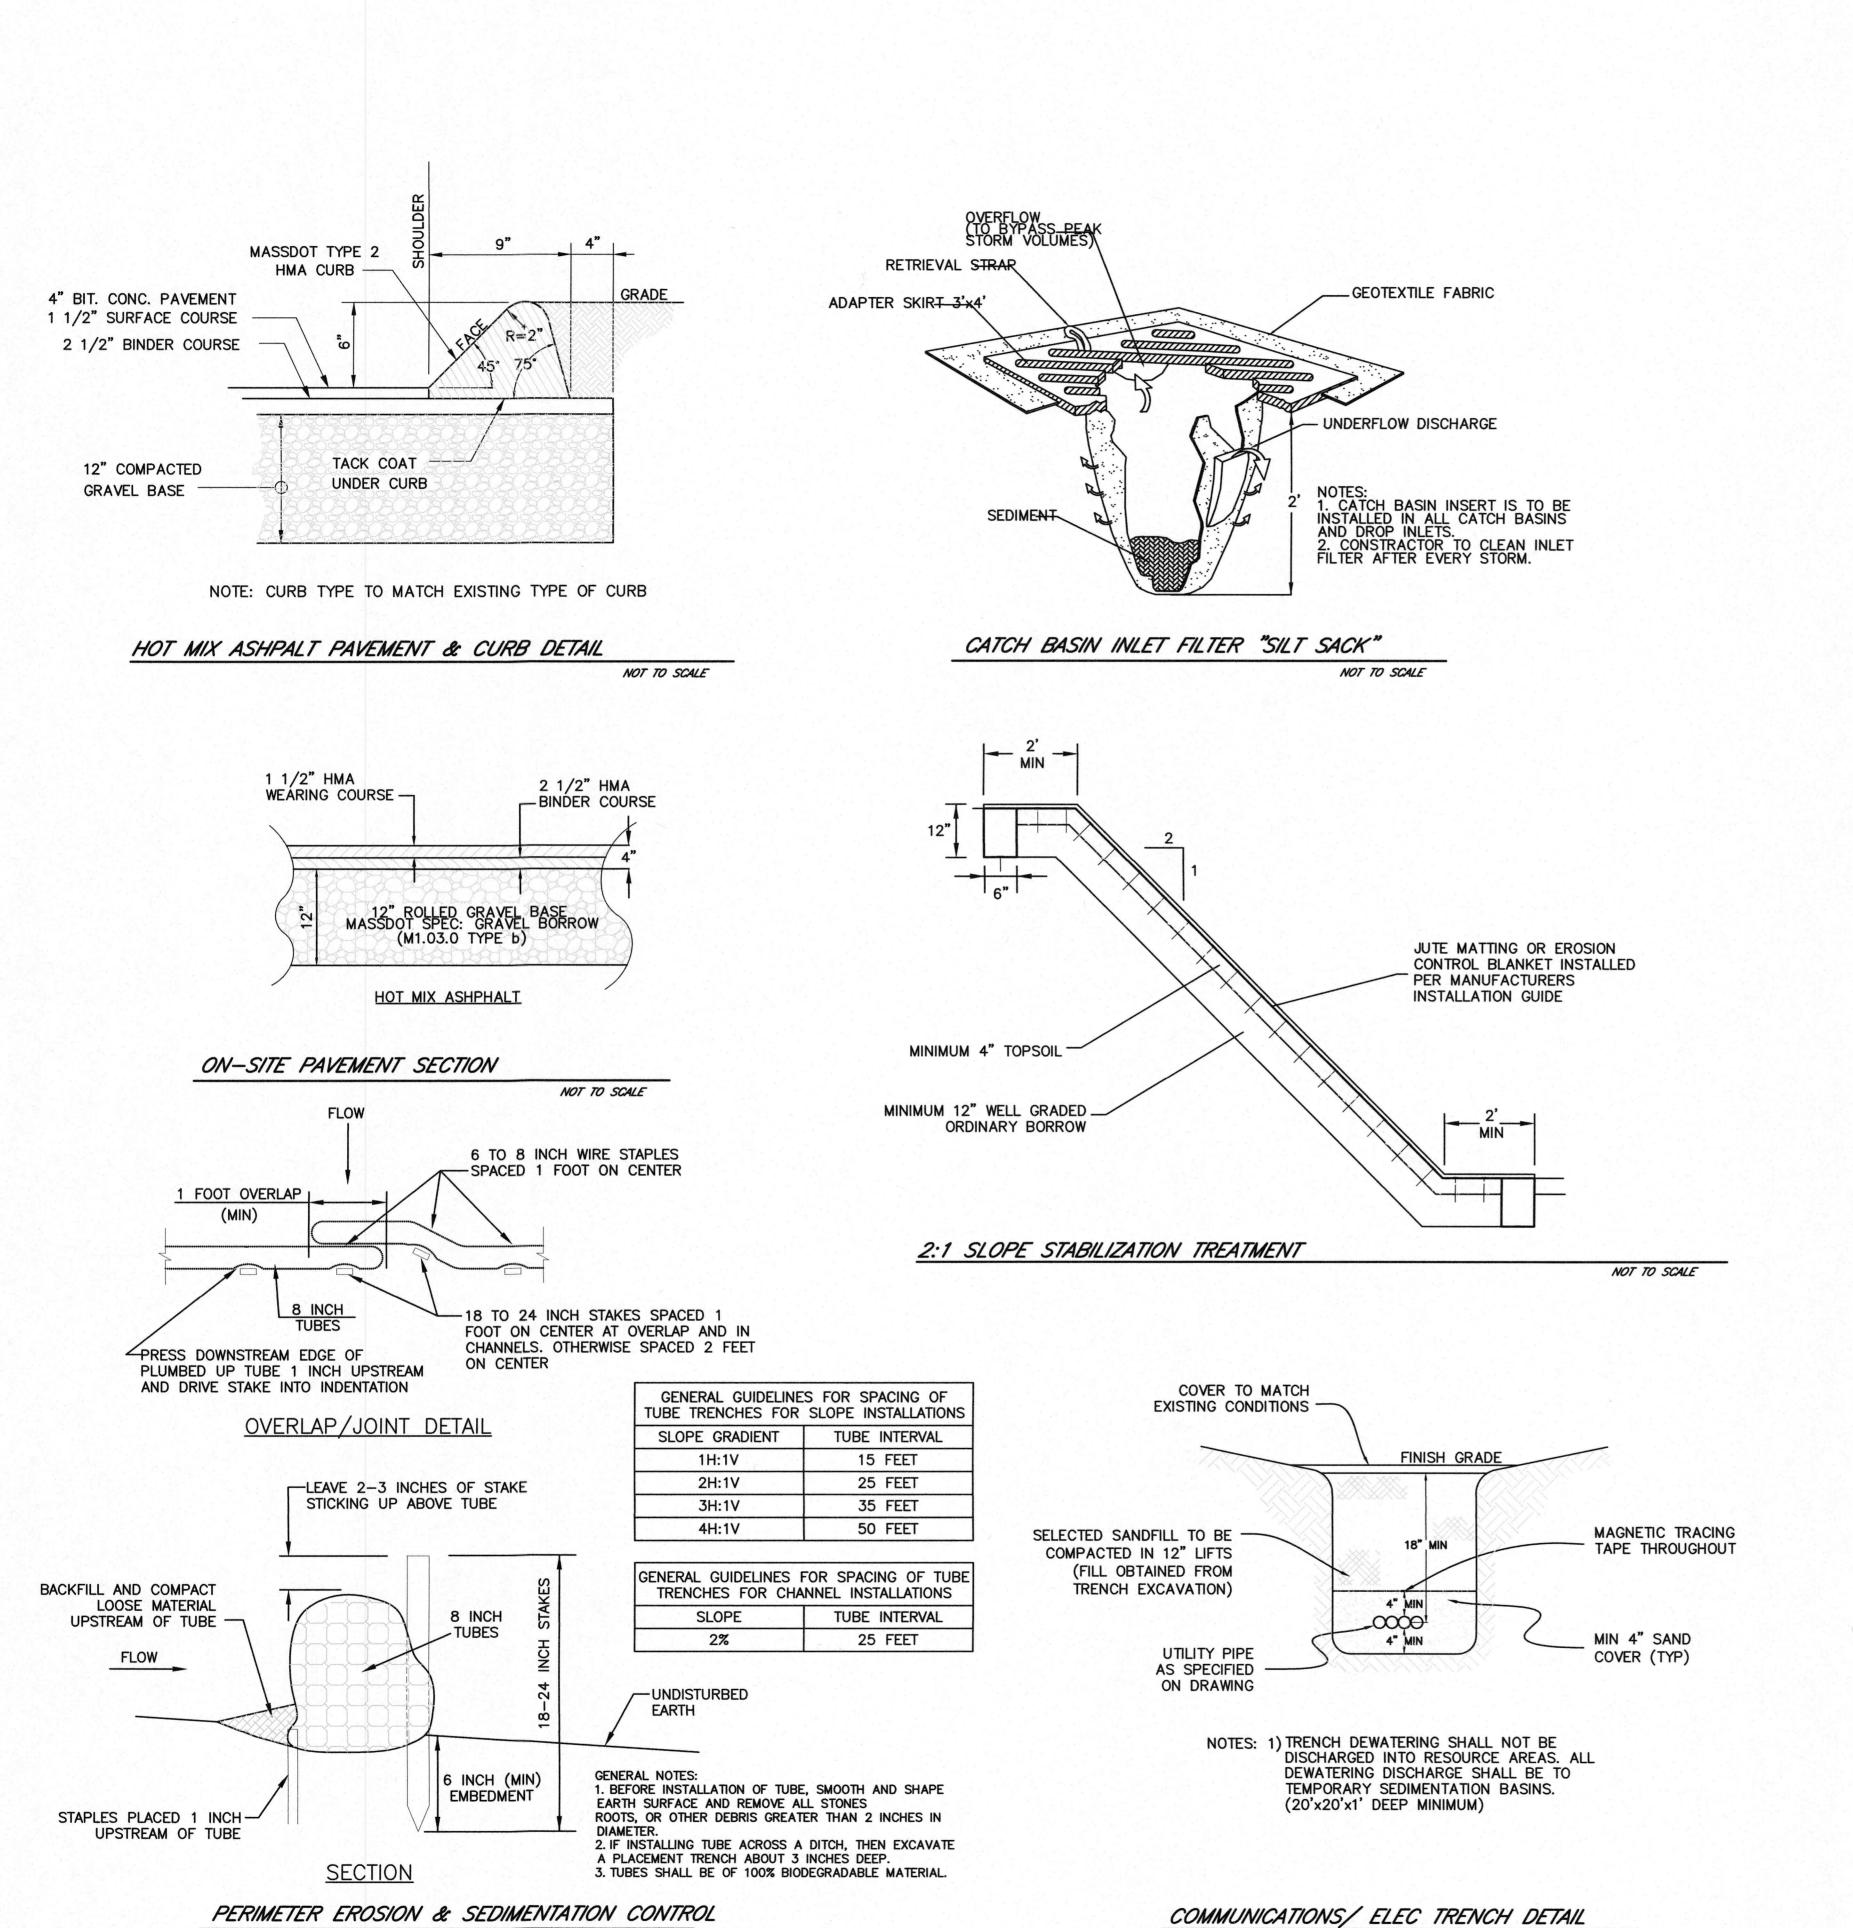

NOT TO SCALE

4" CONCRETE SIDEWALK WITH 1/2"
EXPANSION JOINTS © 20' O.C. AND SCORED CONTROL JOINTS © 5' O.C. (BROOM FINISH)

6" COMPACTED GRAVEL BASE—

TYPICAL SIDEWALK SECTION

NOT TO SCALE


TOP SOIL & SEEDING DETAIL

SEED & LIGHT MULCHING OF CLEAN, WEED-FREE STRAW

TOPSOIL TO BE REMOVED OF DEBRI AND OBJECTIONABLE WEED AND STONES. TOPSOIL SHALL BE FRIABLE AND LOAMY AND CONTAIN NO TOXIC SUBSTANCE HARMFUL TO PLANT GROWTH

UNDISTURBED EARTH

NOT TO SCALE

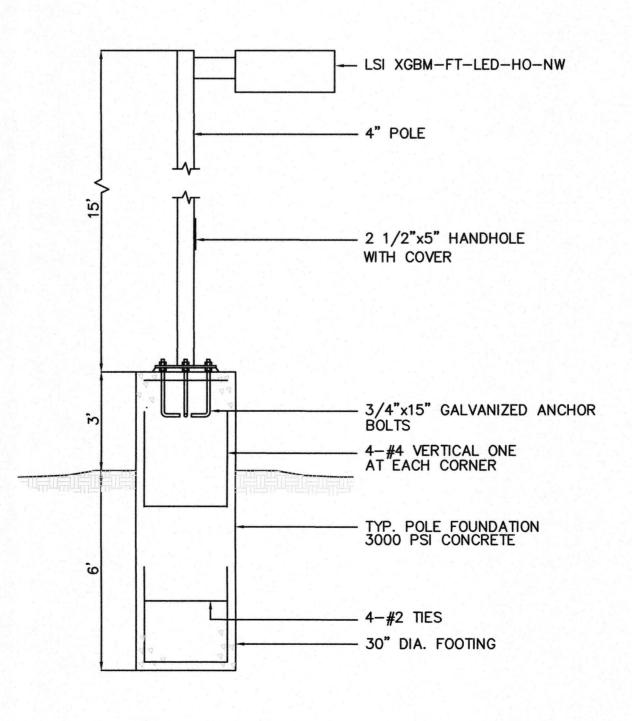

TYPICAL LIGHT POLE FOOTING DETAIL

NOT TO SCALE

NOT TO SCALE

LEICESTER PLANNING BOARD SITE PLAN APPROVAL

DATE:

DETAIL SHEET

DRAWN BY:

PROJ. NO.

CHK BY: SCALE:


C-6

2/14/2020

AS NOTED

151-2058-K

119 Char

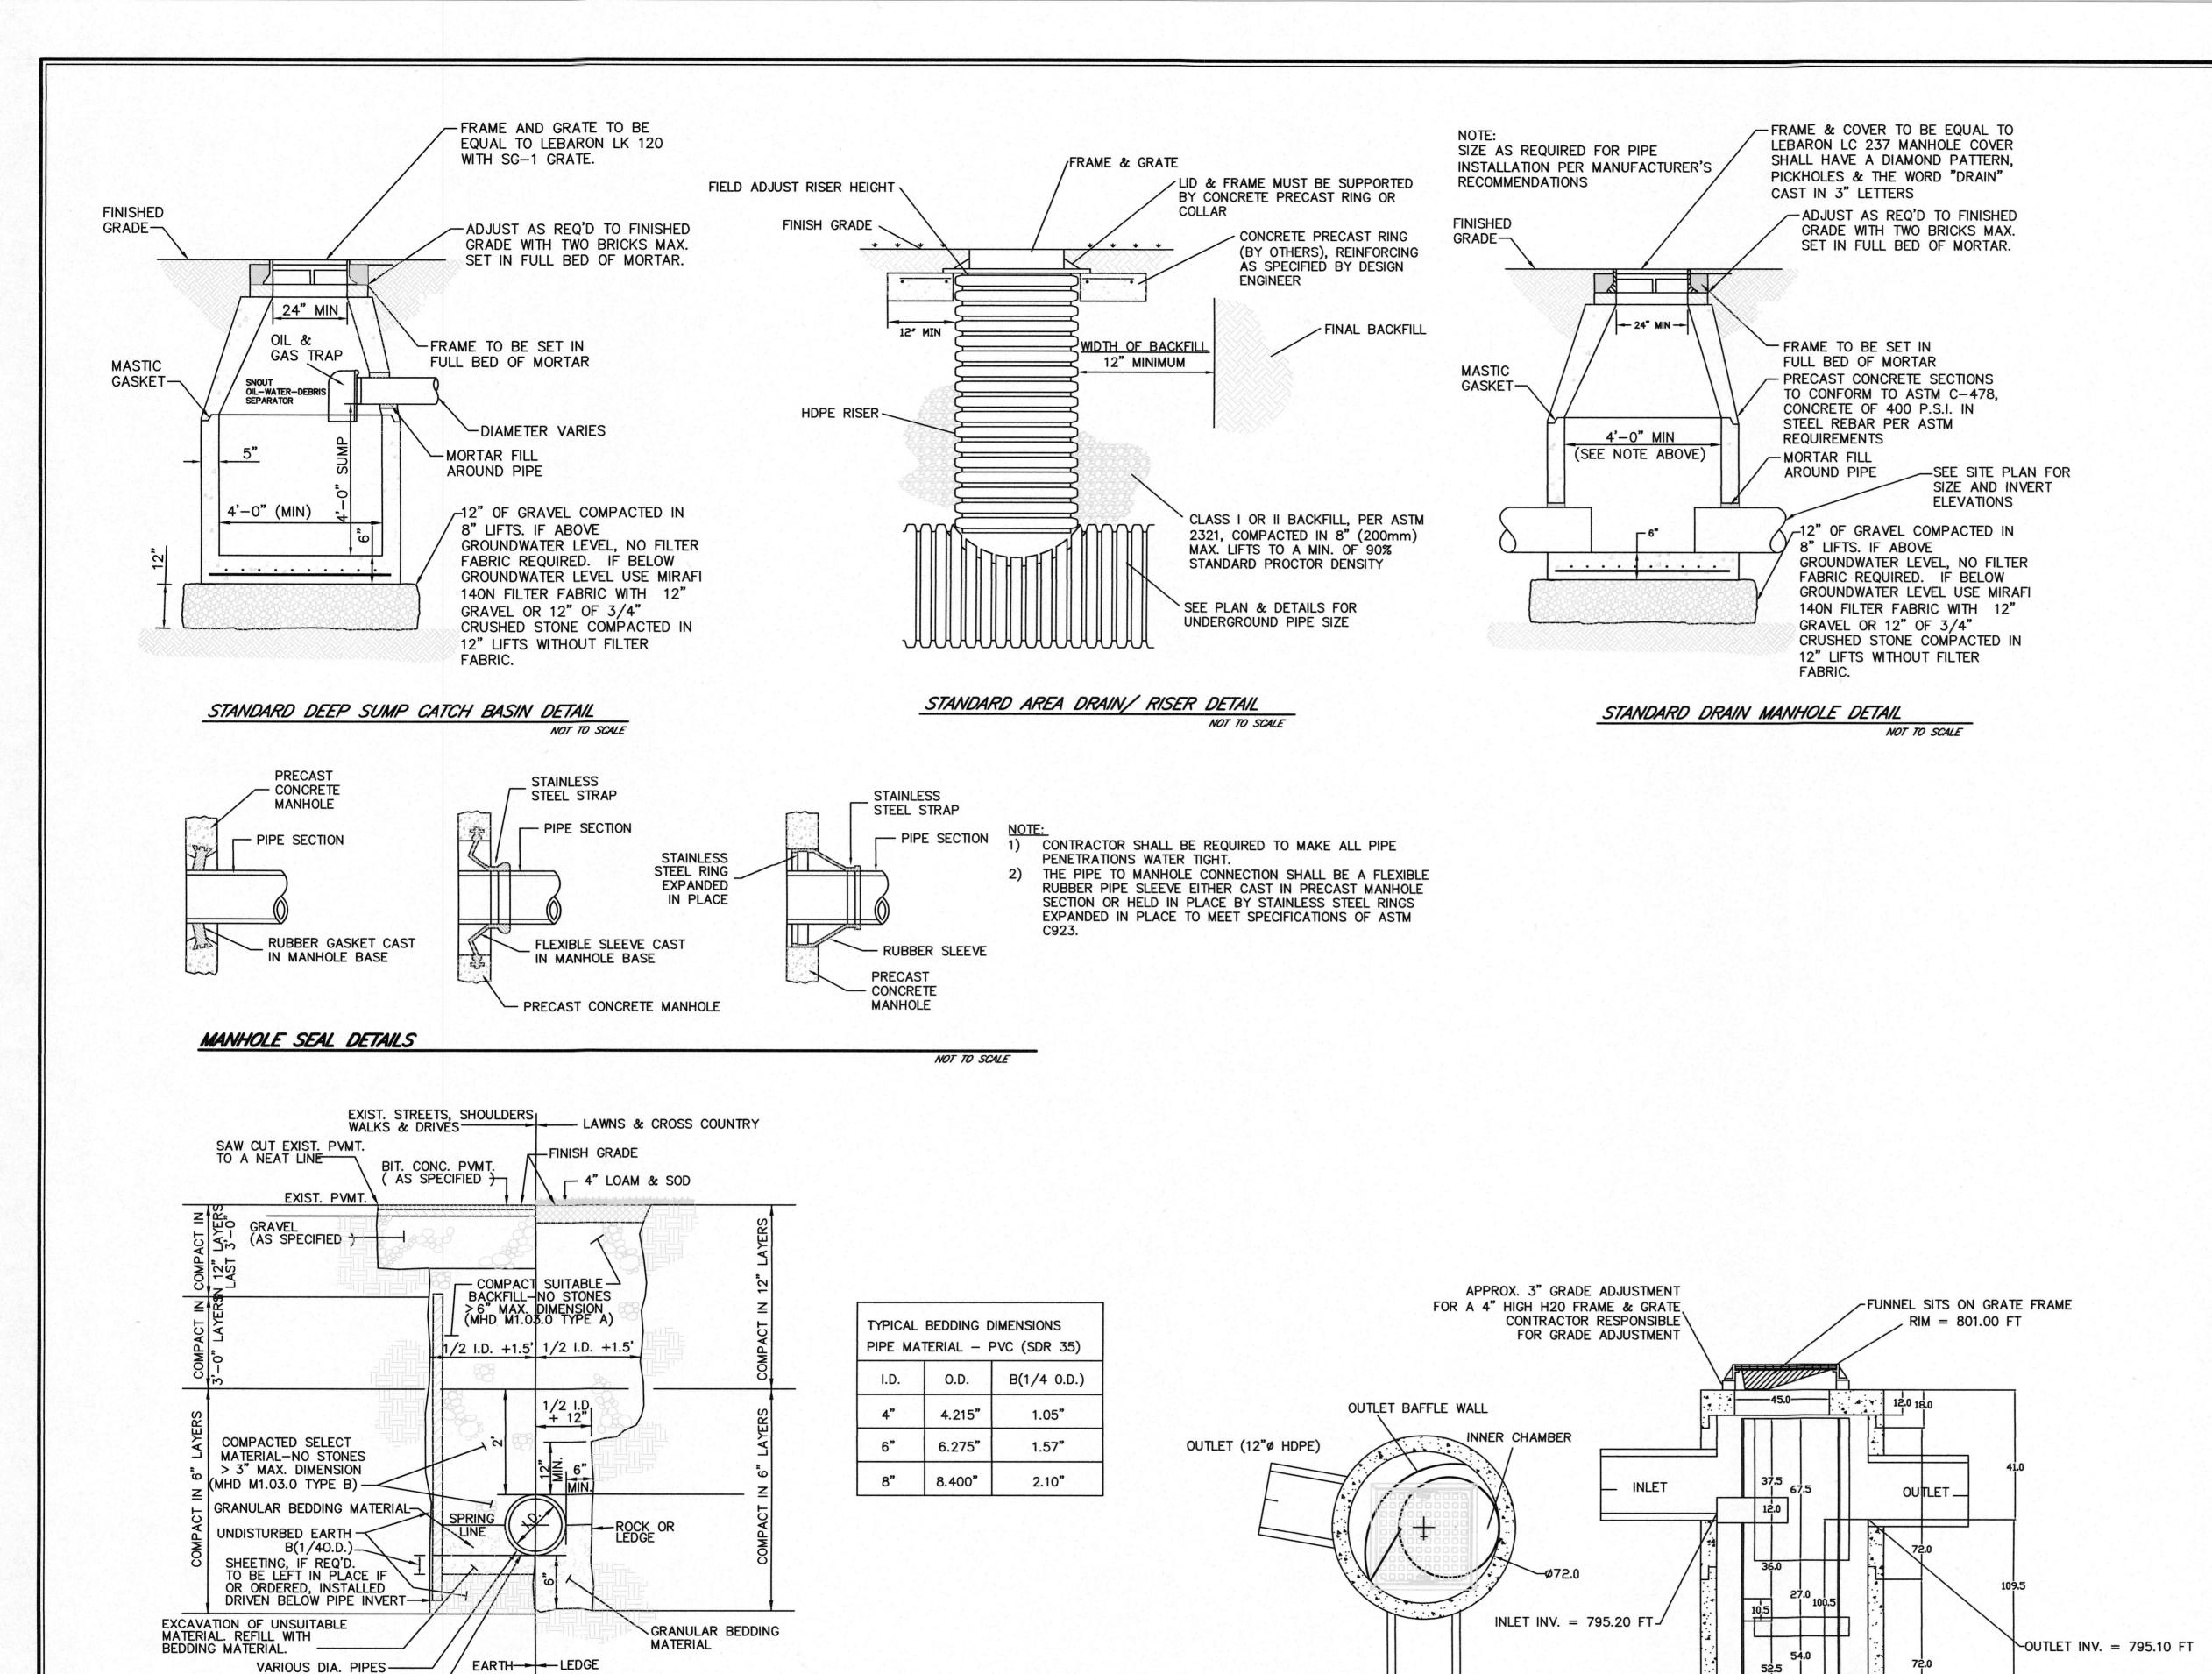

LEICESTER PLANNING BOARD SITE PLAN APPROVAL

> DRAWN BY: DATE: 2/14/2020 AS NOTED PROJ. NO. 151-2058-K

> > **DETAIL SHEET**

**C-7** 

248-248

119 Char

CRE

DATE:

NOT TO SCALE

1. GRANULAR BEDDING MATERIAL SHALL CONSIST OF 3/4" CRUSHED STONE (MHD M2.01.4) OR COMPACTED GRAVEL BORROW (MHD M1.03.0 TYPE C)

2. TRENCH BEDDING & BACKFILL FOR SANITARY SEWERS SHALL BE CLASS B AS DEFINED BY WPCF-MOPQ, AS SHOWN HEREIN.

BOTTOM OF TRENCH SHAPED TO CONFORM TO LOWER 10% OF PIPE-

TYPICAL DRAINAGE TRENCH DETAIL

HYDROWORKS HG4i DETAIL

INLET (12"ø HDPE)

NOT TO SCALE

12"MIN COMPACTED 3/4" CRUSHED STONE