For Planning	Office	Use:
File #:		

#### Leicester Planning Board Site Plan Review & Special Permit Application Form

		_	Special Per		Site Plan Re	view		
Owner I			MATION					
Name:		ar F. Green	еу		Company Name:	E.F.G Rea	Ity Trust	
Signatur	e: 2	obert gre	eney	dot 04/ KY	tloop verified /20/21 11:35 AM EDT [8-MEYK-T5YA-KPN2			
Address	76	Mcclellan	Street, Amho	erst, Massa	achusetts 0	1002		
Phone: (4	413) 2	277-8868		Email:				
Applicar	t Inf	ormation		- T				
Name:	Mark	Klinger			Company Name:	MKEP 770	LLC	
Signatur	e:	Mark Kli	nger	dot 04/ RCF	loop verified 21/21 12:48 PM EDT PN-OAWL-AOGC-AFQZ			
Address	26	5 Sunrise I	Highway, Sui	ite 1368, R	ockville Ce	nter, New Yo	ork 11570	
Phone: (	646) 4	83-2517		Email:	mark@	globalgcny.	com	
Primary	Cont	tact Perso	n (The person	n that will be	contacted by	Planning Boa	rd staff during the app	lication process.)
Name:	Mich	ael Malync	owski		Company Name:	Allen & Ma	ijor Associates, Inc	•
Address	400	0 Harvey F	Road, Suite D	), Manches	ster, New H	ampshire 03	3103	
Phone:	603) 6	627-5500	<u>. (, , , , , , , , , , , , , , , , , , ,</u>	Email:	mmaly	nowski@alle	enmajor.com	
<b>PROJE</b>	CT	INFOR	MATION					
Project Ac	ldress	651 M	ain Street				Zoning District:	Business
Assessors & Parcel #	u de	Lai b	Parcel B5.1		The second secon	Reference & Page):	16761-78	
Applicable	Zoni	ng Bylaw S	ection(s): 3	.2.02				
Proposed	l Lan	nd Use:	Residential	Subdivisio	n (mixes of	Duplexes &	multi-family)	
Existing	Existing Land Use: None							

Page 1 of 2

For Planning	g Office Use:
File #:	

<b>PROJE</b>	ECT	INFO	RMATI	ON.	Contin	ued
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Size of Proposed St		JN, Continued			
-	1	+/- 2,200 square fe	eet		
Total Lot Area:	+/- 29.78 A	cres			
Water Source:	Private	Well	Ch	erry Valley & Rochdale Water Distr	rict
(Select One)	Hillcre	st Water District	Le	icester Water Supply District	
Sewer Source:	Private	Septic System	Ch	erry Valley Sewer District	
(Select One)	Hillcre	st Water District	Le	Leicester Water Supply District	
	Oxford	Rochdale Sewer Distric	t		
20,000s.f. retail building pet grooming clinic.]	g and associat	ed parking; Use of a 1,0 ubdivision composed	000s.f. portion of	c). [Examples: New construction of fan existing structure for a proposed ly 35 lots containing a mix of dup	l
Application Ch Use this checklist to e Review & Special Perm.  Plans (2-full-size & 11"x17")	nsure you ha it Regulations		<i>re required exce</i> Varrative	Drainage Analysis/ Stormwate Report, (3 copies)	er
Documentation of A of Water & Sewer	Availability	Certified Abutters	List (1 copy) <sup>2</sup>	Traffic Study (3 copies)  n/a	
Fees <sup>3</sup>		.pdf copy of all red	quired submittal	s (CD or USB Drive)	
don't require conforman special permit approval certified abutters lists ar construction over 30,000	ce with Site Pla criteria (see Spo e required for a ) s.f. and groun	nn Review submittal require ecial Permit Regulations fo	ements, submit a r r details). ons and for Major 000 s.f or 2 acres o	<del>-</del> -	that
For Planning Boa	ard Use:				
Date of Submittal:					
Public Hearing/Meet	ting Date(s):				
Date of Planning B	oard Vote				
Date Or Flamming B					

Page 2 of 2 rev. 6-2017 allenmajor.com



July 19, 2021

To: A&M Project #: 2889-01

Michelle R. Buck, Town Planner

Re:

Definitive Subdivision Plan

Leicester Development and Inspectional Services

651 Main Street

Leicester Development and Inspectional Services 651 Main Street
3 Washburn Square Map 21/Parcel B5.1

Leicester, Massachusetts 01524

Copy:

Dear Ms. Buck

On behalf of our client, MKEP 770, LLC, the Applicant, Allen & Major Associates, Inc. is filing a Preliminary Subdivision Plan for the construction of a proposed subdivision off Main Street in Leicester, Massachusetts. The project includes land depicted on the Assessor's Map #21 as Parcel B5.1 (651 Main Street), owned by E.F.G. Realty Trust. The plans submitted intend to depict the land encompassing the subdivision based on the Existing Conditions Plan created by Allen & Major Associates, Inc. Dated: July 16, 2021.

It is the intent of the applicant to create a subdivision with three roadways to provide access to 32 new building lots. Of these newly created lots, 30 lots will accommodate the construction of a single duplex residential building and consist of a minimum of 0.52 acres in size. The remaining two (2) lots will be developed with a townhome style homes consisting of approximately 7 units each. The total development will have 74 new residential units.

The project property is located along the southwestern side of Main Street and northern side of Henshaw Street. The majority of the property consists of mainly woodland and brush, with a brook and small wetland pockets near the property's boundary. Electrical utility lines and a tower are located at the southwestern portion of the parcel. As stated above, the existing electrical utility lines will be separated from the development and protected by a 250 foot electric easement.

As part of the proposed development, three interconnected roadways will be constructed to provide access to individual lots. Being considered a residential subdivision, the roadways are proposed to be 28-feet wide with a 40-foot wide right of way to be maintained. The primary access will be situated along Main Street approximately 500 feet southeast of Waite Street intersection. The proposed roadway network is interconnected by means of an emergency access from Colonial Drive. The first main intersection into the development is approximately 880 feet from Main Street.

Along with the construction of the proposed roadway, several other utility improvements will be provided as part of the overall development. The project stormwater management system will be addressed by a system of catchbasins and drainage manholes, capturing the surface runoff and directing it to various drainage detention basins for peak rate mitigation and stormwater treatment. An initial review of the drainage system and watersheds has been performed and the Grading & Drainage Plan depicts the anticipated drainage system for the project. A full stormwater analysis will be provided as part of the Definitive Subdivision submittal.

#### **Environmental Analysis**

As this proposed subdivision will be creating frontage potentially allowing ten (10) or more family units, an Environmental Analysis has been provided herein. Many of the items outlined within the Environmental Analysis have be detailed within other plans or within the stormwater report, below is a summary of the specific items of concern.

- a.) The same data as on the Definitive Plan
  Refer to plans prepared by A&M dated July 16, 2021 consisting of approximately 19 sheets.
- b.) Topography at two foot contour intervals, with graphic drainage analysis; indication of annual high water mark, location of existing structures, including fences and walls, and watershed boundaries.

  Topographic information is shown on Sheet V-101 including existing structures, fences, walls and delineated

resource areas. The existing and proposed watershed plan were prepared and included within the submitted Stormwater Report, refer to Sheet WS-1 and WS-2.

c.) Vegetation cover analysis, including identification of general cover type (wooded, cropland, brush, wetland, etc.); location of all major tree groupings, plus other outstanding trees or other botanical features; important wildlife habitats; and identification of areas not to be disturbed by construction.

The vast majority of the site consists of wooded cover with some areas of grass and brush. There are also several areas of delineated resource areas adjacent to Colonial Drive and Henshaw Street. Additional, the southwest section of the property is bisected by an existing electrical transmission line easement. The areas can be seen on Sheet V-101. As part of the stormwater analysis for the project both the existing and proposed surface covers were calculated. A summary of these area are listed below and additional information can be found in the stormwater report in Section 4 and Section 5.

#### Existing

Area (acres)	Description (subcatchment-numbers)
1.734	>75% Grass cover, Good
2.164	Brush, Good
0.071	Paved parking
25.418	Woods, Good

#### **Proposed**

Area	Description (subcatchment-numbers)
(acres)	Description (subcateriment manuscrs)
15.777	1/2 acre lots, 25% imp
2.501	>75% Grass cover, Good
2.164	Brush, Good
3.603	Paved parking
5.339	Woods, Good

d.) Soil types, based on United State Department of Agriculture (USDA) soils study; approximate ground water level, location and results of soil percolation or other sub surface tests.

As the project is proposed to be on municipal sewer, soil percolation tests were not performed on the site. Published soil information from USDA and NRSC were utilized to approximate a design infiltration rate for the proposed roof drainage infiltration system.

e.) Visual analysis, including analysis of scenic vistas, and locations of visual prominence.

Although the project is situated on a elevated portion of the site, there are no significant scenic vistas that will be created nor impacted as part of the project.

f.) Location of surface water bodies, wetlands, aquifer or recharge areas for existing or potential drinking water supplies.

The vast majority of the site consists of wooded cover with some areas of grass and brush. There are also several areas of delineated resource areas adjacent to Colonial Drive and Henshaw Street. Additional, the southwest section of the property is bisected by an existing electrical transmission line easement. The areas can be seen on Sheet V-101.

The following narrative will set to document the following, with reference to the above maps as germane.

#### a) Impact upon surface water quality and level.

As part of the proposed project, impacts to surface water quality will be enhanced through the implementation of a new stormwater collection system. The stormwater collection system is a series of inlets located at low points within the limits of the paved area. All of the proposed on-site catch basins incorporate a deep sump and hooded outlet. The catch basins are connected by a closed gravity pipe network that pass through proprietary separators prior to entering the pipe detention systems or gabion walls.

The proposed stormwater management system has been designed to remove 80% of the average annual post-construction load for each treatment train. The TSS removal calculations can be seen within the appendix of the stormwater report. Structural Pretreatment BMPs consisting of Deep sump catch basins, also known as oil and grease or hooded catch basins, are underground retention systems designed to remove trash, debris, and coarse sediment from stormwater runoff, and serve as temporary spill containment devices for floatables such as oils and greases. Further treatment is provided via a proprietary separator this is a flow-through structure with a settling or separation unit to remove sediments and other pollutants. They typically use the power of swirling or flowing water to separate floatables and coarser sediments, are typically designed and manufactured by private businesses, and come in different sizes to accommodate different design storms and flow conditions.

As a further management system, a Long-Term Operation & Maintenance (O&M) Plan has been developed for the proposed stormwater management system and is included within the stormwater report. The purpose of the O&M is to identify potential sources of pollution that may affect the quality of stormwater discharges, and to describe the implementation of practices to reduce the pollutants in stormwater discharges.

#### b.) Impact upon ground water quality and level.

As indicated above, the proposed project, impacts to surface water quality will be enhanced through the implementation of a new stormwater collection system which will provide for pretreatment. The existing annual recharge for the site has been approximated in the proposed condition. Groundwater recharge will be provided through the use of proposed dry wells that are designed to meet this requirement. The proposed Recharge Volume is based on the Static Method per the MA DEP Stormwater Management Standards, Volume 3, Chapter 1. See the appendix located at section 6 of this report for stormwater recharge calculations.

c.) Effects on important wildlife habitats, outstanding botanical features, scenic or historic sites or buildings. The property contains several areas subject to the Wetland Protection Act, all of which being outside direct impacts associated with the proposed roadway construction. These areas have been delineated by Gove Environmental Services, Inc. and are depicted on the Proposed Subdivision Plan. Some of the proposed drainage detention/infiltration basins are proposed to be located within the buffer zone and a filing with the Conservation Commission will be required. This will be made concurrent with the Definitive Subdivision review process.

Upon review of the Commonwealth's published data, there were no Areas of Critical Environmental Concern (ACEC); Outstanding Resource Waters (ORWs) nor areas of Priority and Protected Habitat for rare and endangered species located within the project limits. See Exhibit 3.4 within the submitted stormwater report.

d.) Capability of soils and vegetative cover to support proposed development without erosion, silting or other instability.

Existing Soil Conditions: The on-site soils were identified using the USDA Natural Resources Conservation Services (NRCS) Soil Survey for Worcester County. The site contains a range of soil types including: Ridgebury, Whitman, Paxton, Woodbridge, Charlton, Canton, and Udorthents. The majority of the site is made up of Paxton fine sandy loam. A copy of the NRCS Custom Soil Resource Report is included in the appendix of the stormwater report.

A plan to control construction-related impacts, including erosion, sedimentation and other pollutant sources during construction has been developed. A detailed Erosion and Sedimentation Control Plan is included in the Permit Drawings. Refer to Sheet C-100 for location of proposed erosion control measure and Section 2 of the Stormwater Report for additional information. The proponent will prepare and submit a Stormwater Pollution Prevention Plan (SWPPP) prior to commencement of construction activities that will result in the disturbance of one acre of land or more.

The proposed stormwater management system for the site will control the Peak Rate of Runoff through the use of deep sump catch basins, pipe detention systems, a detention basin, outlet control structures, and gabion walls (level spreaders). These systems have been designed in accordance with the MA DEP Stormwater Management Policy to recharge groundwater and reduce rate of runoff from the parcel.

e.) Relationship to Massachusetts General Laws, Chapter 131, Sections 40, (Wetlands Protection Act) and Town Wetland Bylaw.

The property contains several areas subject to the Wetland Protection Act, all of which being outside direct impacts associated with the proposed roadway construction. These areas have been delineated by Gove Environmental Services, Inc. and are depicted on the Proposed Subdivision Plan. Some of the proposed drainage detention/infiltration basins are proposed to be located within the buffer zone and a filing with the Conservation Commission will be required. This will be made concurrent with the Definitive Subdivision review process.

- f.) The report shall estimate the proposed traffic flow in relation to the roadways giving access to the subdivision. The property contains several areas subject to the Wetland Protection Act, all of which being outside direct impacts associated with the proposed roadway construction. These areas have been delineated by Gove Environmental Services, Inc. and are depicted on the Proposed Subdivision Plan. Some of the proposed drainage detention/infiltration basins are proposed to be located within the buffer zone and a filing with the Conservation Commission will be required. This will be made concurrent with the Definitive Subdivision review process.
- g.) The report shall estimate the effect of the project on public services, such as water, sewer, schools, police, fire and highway department.

#### **Traffic**

Traffic generated by the proposed convenience store re-development was determined based on the "Institute of Transportation Engineers (ITE) Trip Generation Manual, 10th Edition". The trip generation rates were based on Land Use Code 270, defined as a Residential Planned Unit Development. The estimated vehicle trips generated are shown in the following table:

The estimated vehicle trips are shown in the following tables:

Weekday	Total	Incoming	Outgoing
Daily	546	273	273
AM Peak	43	10	33
PM Peak	53	34	19

Saturday	Total	Incoming	Outgoing
Daily	505	252	253
Midday Peak	41	20	21

As part of the permitting process, a driveway access permit will be sought through the Massachusetts Department of Transportation as Main Street, aka Route 9 is within the jurisdictional control of MDOT.

#### Water & Sewer

Both water and sewer will be provided through municipal services. In a letter obtained from Cherry Valley Sewer District, the project is available for hook-up to the public sewer system. The project proposes sewer manholes to be placed within the newly aligned roadways at various locations to collect sewage and direct it to the existing municipal sewer system along Main Street. In a letter obtained from Leicester Water Supply District, there is adequate water supply for the proposed development. Domestic water for the property is intended to be sourced from the existing municipal water main within Main Street.

#### Police, Fire & Highway Department

Based on email correspondence received from Fire Chief Dupuis and Police Chief Antanavica, they have both met on site to review the proposed project and do not have any concerns at this time. Street lighting is being proposed which will help deter suspicious activities from taking place within the development. The project proposes a new municipal water service, including strategic placement of fire hydrants throughout the development to lessen the burden on any potential firefighting activities that may occur.

#### **Schools**

Of the 60 duplex units, approximately 24 units will have a layout which places the living quarters all on the first floor. This set up if more conducive to young professionals or older couples without children, so it is presumed that these units would not have an impact on the school system. Based on the remaining 50 units (36 duplex units and 14 townhomes) will consist of a minimum of 2 bedrooms situated on multiple floors which is more desirable for potential families with children. Based upon this presumption and the local average of 1.5 children per dwelling unit, it is anticipated that the project could produce 75 school age children. Based on discussion with school superintendents office about the impact on the schools for 74 homes. Here is what she said and the reports from the state.

- 1. K-4 would put a strain on the system, the school is at capacity.
- 2. Middle School They can handle the new homes.
- 3. High School They can heddle the new homes.

#### **Special Permit Criteria Evaluation**

- 1. Such use will not nullify or substantially derogate from the intent and purpose of this Bylaw;
  The proposed use (duplex & townhouse) will not alter the general character of the surrounding area nor impair the intent or purpose of said bylaw because the proposed use conforms to the existing residential dwellings in the area. Although there are proposed to be 30 duplex units of slightly varying size and configuration, the same general characteristics will be consistent, including separated building entrances and buffered driveways to aid in the appearance of each being a separate unit.
- Such use will not constitute a nuisance; and
   As the proposed project is for a residential development in a

As the proposed project is for a residential development in accordance with Town standards, it will not constitute a nuisance to the surrounding area. Through the development of comprehensive stormwater management system, the site will control post development stormwater flows to below predevelopment conditions. Additionally, an extensive erosion control plan has been prepared, included a construction phase protections to prevent erosion concerns to abutting properties.

- 3. Such use will not adversely affect the neighborhood in which the lot is situated.

  The proposed residential development which includes 30 duplex units and 14 townhouse units will not adversely affect the surrounding neighborhoods as the layout has been designed to provide a consolidated entrance to the project along Main Street (Route 9). The proposed duplex home, although connected, are designed to provide a sense of separation through the placement of interior spaces as well as landscape buffers.
- 4. Such use complies with the Standards for Site Plan Approval in the Leicester Zoning Bylaw.

  The proposed use (duplex & townhouse) will not alter the general character of the surrounding area nor impair the intent or purpose of said bylaw because the proposed use conforms to the existing residential dwellings in the area.

As part of this submittal, and in effort to provide comprehensive review for the Definitive Subdivision submittal, a preliminary list of waivers to the Leicester Subdivision Regulations is being submitted herewith. The applicant reserves the right to amend the list of waivers as needed during the Definitive Subdivision design and review process.

#### **Waivers:**

Section V.A.1.f - Minimum center line radii. 200' min. Required

To allow center line radius of 75' and 100'. This happens along the first segment of the entrance road to allow for a bit longer path of travel to help overcome the existing topography. A truck turning simulation has been prepared illustrating that fire apparatus can maneuver the roadway network without impacts to oncoming vehicles.

Section V.A.3.a - maximum street grade. 10%

To allow for a street grade of 14% between Sta 1+00 & STA 5+00 along alignment #9 and 20% between Sta 13+50 & Sta 16+00 along alignment #7

Section VI.B.1a – reinforced concrete storm drainage piping required

A waiver is requested to utilize high density polypropylene (HDPE) drainage lines or approved equal within the drainage system of the subdivision.

#### Section VI.e.3 - street lighting required

To allow street lighting to be installed as private driveway light. Each lot shall be provided with a standard lamp post light on the lot near the intersection of the driveway with the street right-of-way line. Each lot light shall be placed on a dusk till dawn timer and shall be maintained by the individual property owner in perpetuity as stated in the proposed covenants.

#### Section VI.I - Street trees shall be installed on both sides of the roadway

To allow for street tree plantings to be installed on one side only. Since the minimum right of way is fully consumed by street paving and sidewalks along each side, there is not sufficient area for the installation of street trees within the right-of-way. It is being requested that street trees be incorporated into the individual landscaping of the private lots near the intersection of the driveway with the street right-of-way.

#### Section VI.G.1 - Sidewalks shall be installed on both sides of all streets within a subdivision

A waiver is requested to install sidewalks on only 1 side of the roadway due to the steep terrain of the proposed subdivision and lack of connection to a municipal sidewalk along Main Street (aka Route 9)

At this time, Allen & Major Associates, Inc. is requesting to be placed on the agenda for the next available meeting of the Planning Board to discuss this Preliminary Subdivision Plan. Representatives of this office and the owner/applicant will attend to present the plan and address any concerns raised by the Board at that time. We thank you in advance for your anticipated cooperation regarding this project and look forward to meeting to discuss the plans.


Very Truly Yours,

**ALLEN & MAJOR ASSOCIATES, INC.** 

Ichael Malynaushi

Michael Malynowski, PE Senior Project Manager

Help Corinne Tobias Sign out

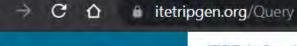



ITETripGen Web-based App

Graph Look Up

Technical Support


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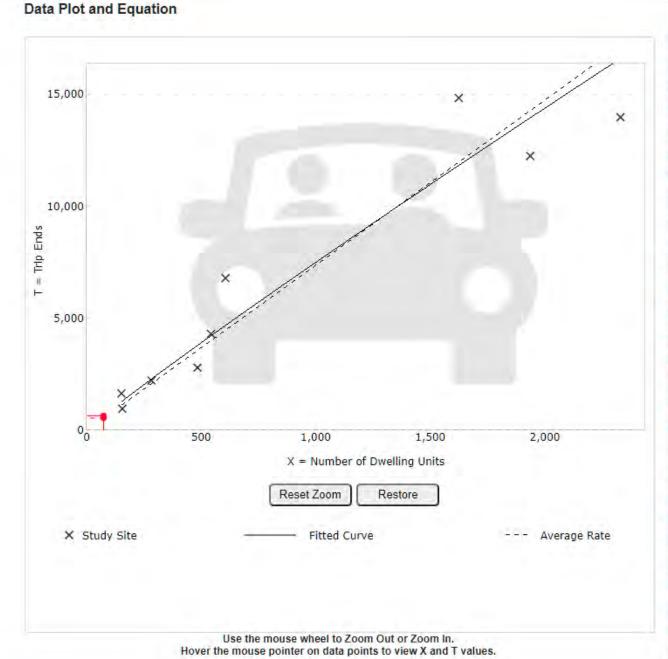
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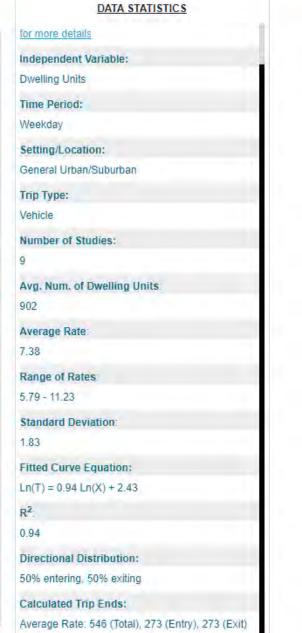
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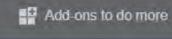








Fitted Curve: 649 (Total), 324 (Entry), 325 (Exit)

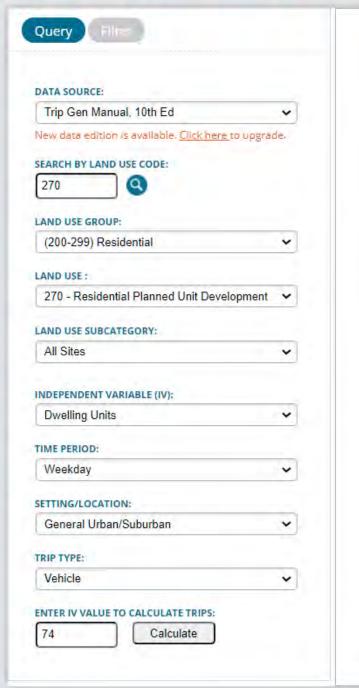

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**Data Plot and Equation** 

DATA STATISTICS







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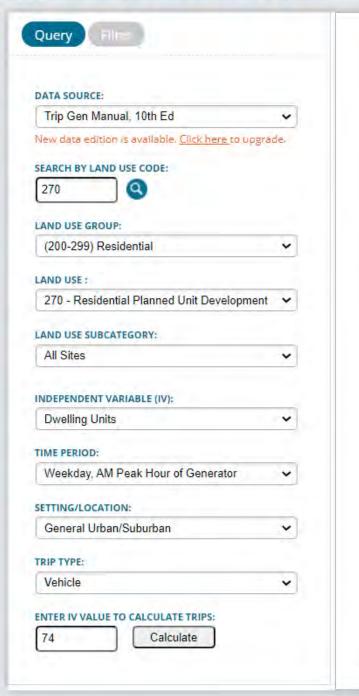
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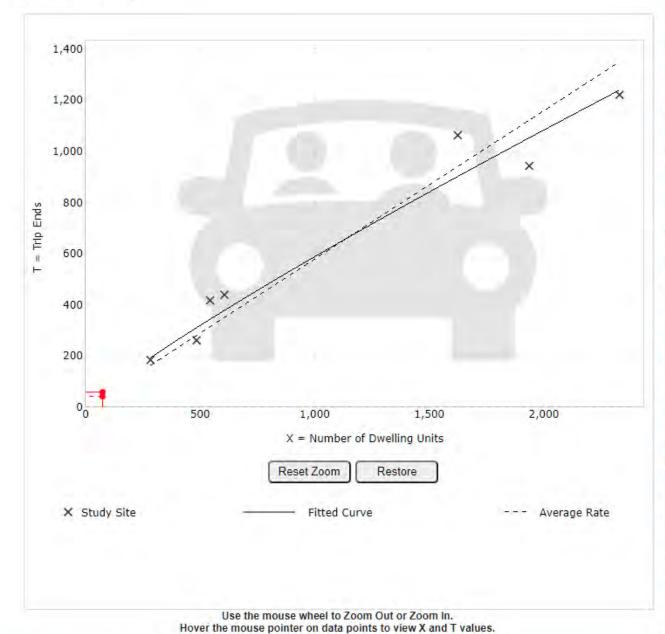
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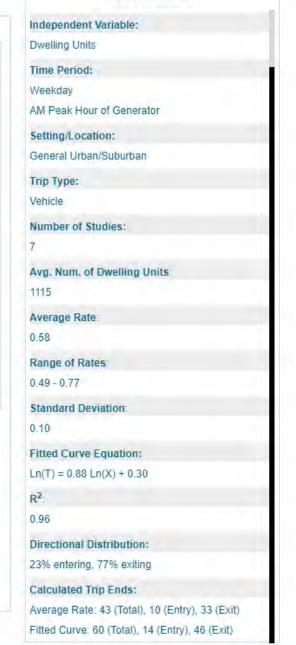












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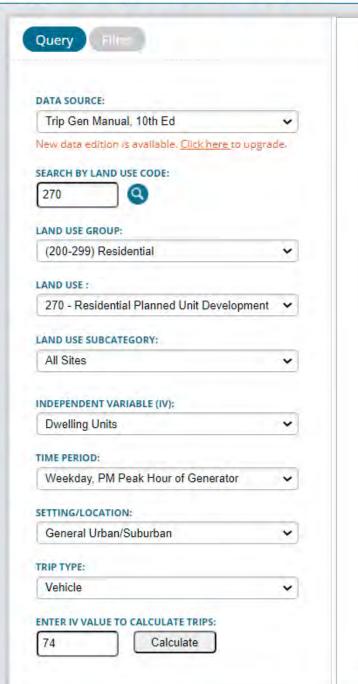
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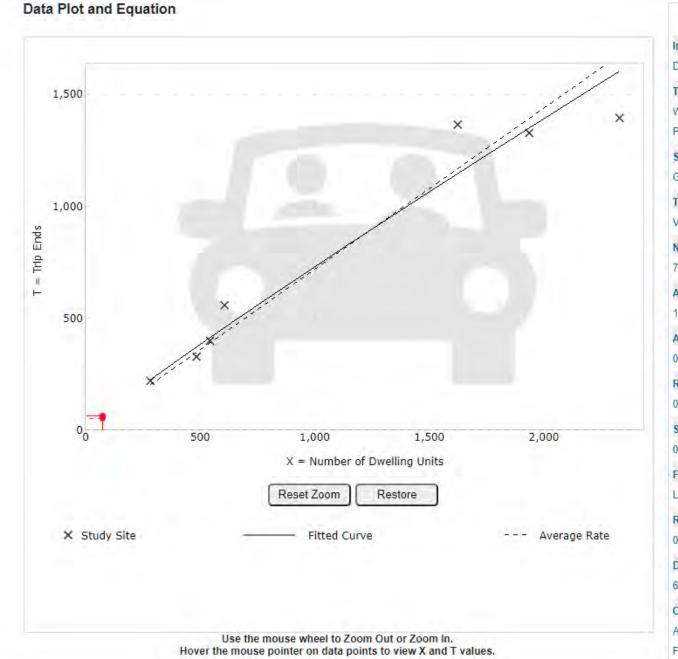








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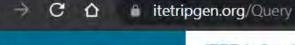






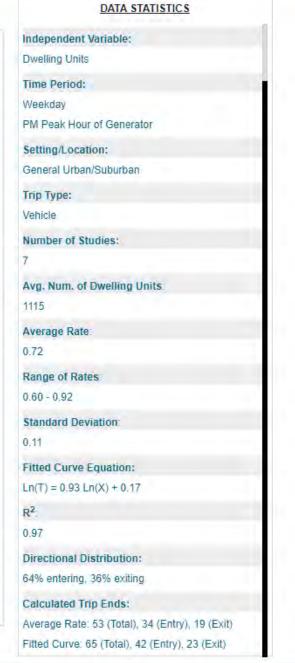
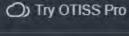
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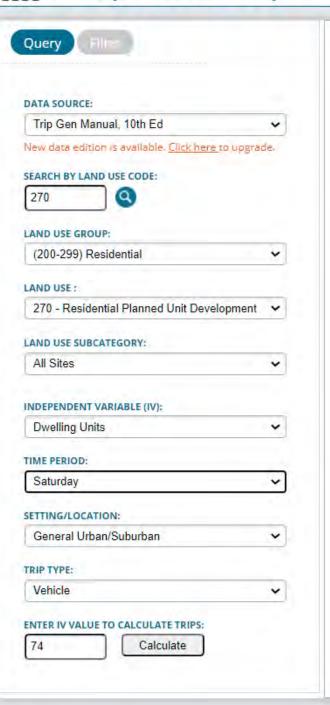













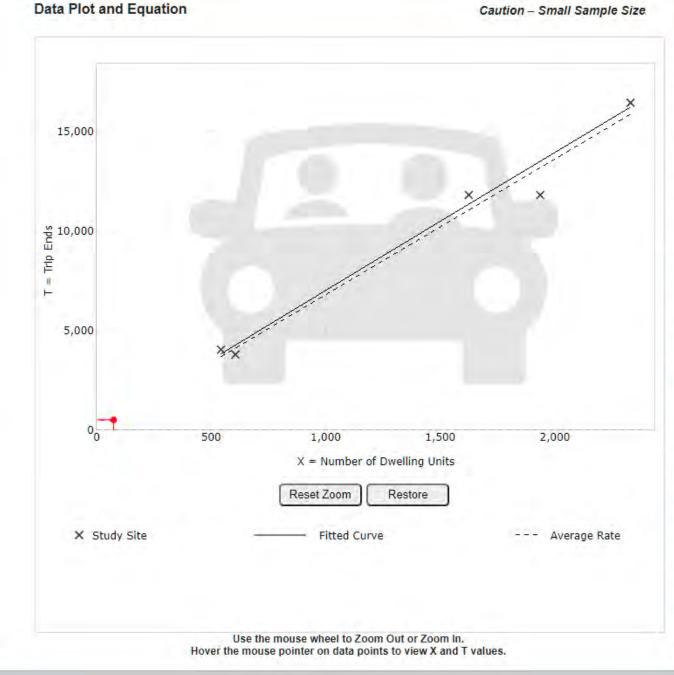



DATA STATISTICS

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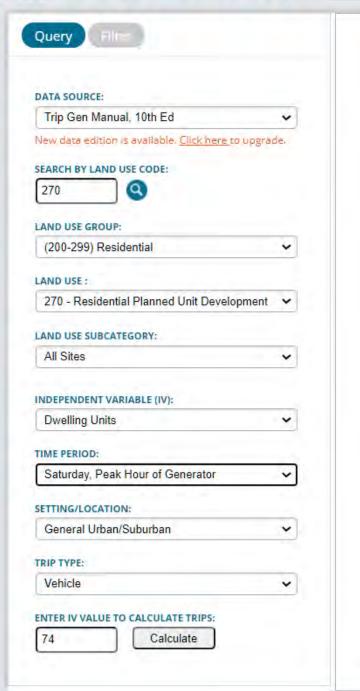
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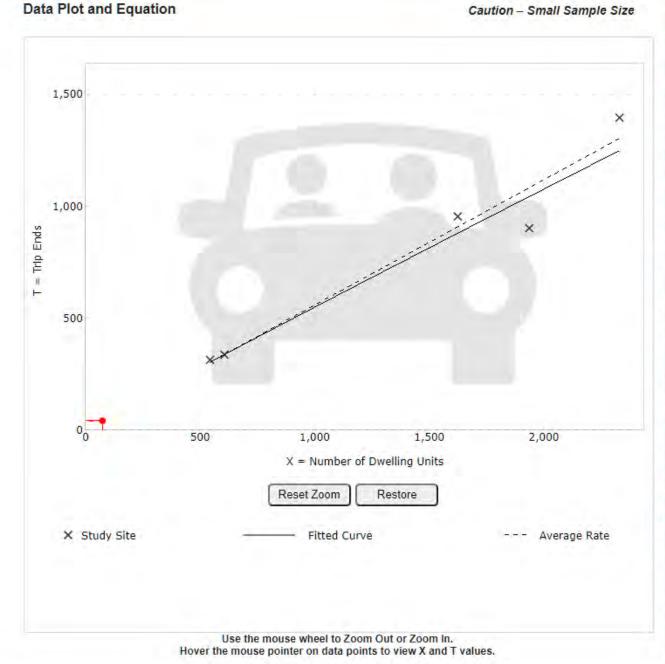
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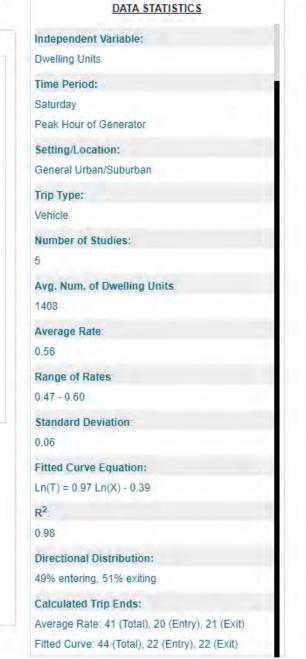
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### **Massachusetts School and District Profiles Leicester**

2019-20 Class Size by Gender and Selected Populations - All

Subject:	All	~	þ
Subject.		~	Þ

#### More about the data.

Selected Populations	District	State
Total # of Classes	631	460,027
Average Class Size	19.6	17.9
Number of Students	1,512	959,877
Female %	46.2	48.6
Male %	53.6	51.4
English Language Learner %	4.2	10.8
Students with Disabilities %	16.7	18.2
Economically Disadvantaged %	27.8	34.4

#### **Massachusetts School and District Profiles Leicester**

#### **Enrollment Data**


Enrollment by Race/Ethnicity (2020-21)				
Race	% of District	% of State		
African American	5.2	9.3		
Asian	3.2	7.2		
Hispanic	12.9	22.3		
Native American	0.1	0.2		
White	75.5	56.7		
Native Hawaiian, Pacific Islander	0.0	0.1		
Multi-Race, Non-Hispanic	3.1	4.1		

Enrollment by Gender (2020-21)						
	District	State				
Male	733	467,362				
Female	639	443,625				
Non-Binary	2	478				
Total	1,374	911,465				

Enrollment by Grade (2020-21)																
	PK	K	1	2	3	4	5	6	7	8	9	10	11	12	SP	Total
Leicester Elementary	0	80	97	90	117	92	0	0	0	0	0	0	0	0	0	476
Leicester High	0	0	0	0	0	0	0	0	0	0	112	98	131	99	0	440
<u>Leicester Integrated</u> <u>Preschool</u>	33	0	0	0	0	0	0	0	0	0	0	0	0	0	0	33
Leicester Middle	0	0	0	0	0	0	88	96	128	113	0	0	0	0	0	425
District	33	80	97	90	117	92	88	96	128	113	112	98	131	99	0	1,374

K	Kindergarten Enrollment (2020-21)								
Student Group		Kindergarte	Full-day Kindergarten						
	Total	Part-time	Tuitioned	Full-time	Total	Percent			
All Students	80	0	0	80	80	100.0			
High Needs	39	0	0	39	39	100.0			
Economically Disadvantaged	30	0	0	30	30	100.0			
LEP English language learner	7	0	0	7	7	100.0			
Students with disabilities	13	0	0	13	13	100.0			
African American/Black	4								
Asian	4								
Hispanic or Latino	10	0	0	10	10	100.0			
Multi-race, non-Hispanic or Latino	5								
White	57	0	0	57	57	100.0			

Pre-Kindergarten Enrollment (2020-21)						
Student Group	Total PK Enrolled	# Student Group Enrolled	% Student Group Enrolled			
All Students	33	33	100.0			
Female	33	19	57.6			
High Needs	33	22	66.7			
Male	33	14	42.4			
Economically Disadvantaged	33	14	42.4			
Students with disabilities	33	17	51.5			
African American/Black	33	1	3.0			
Hispanic or Latino	33	7	21.2			
Multi-race, non-Hispanic or Latino	33	2	6.1			
White	33	23	69.7			

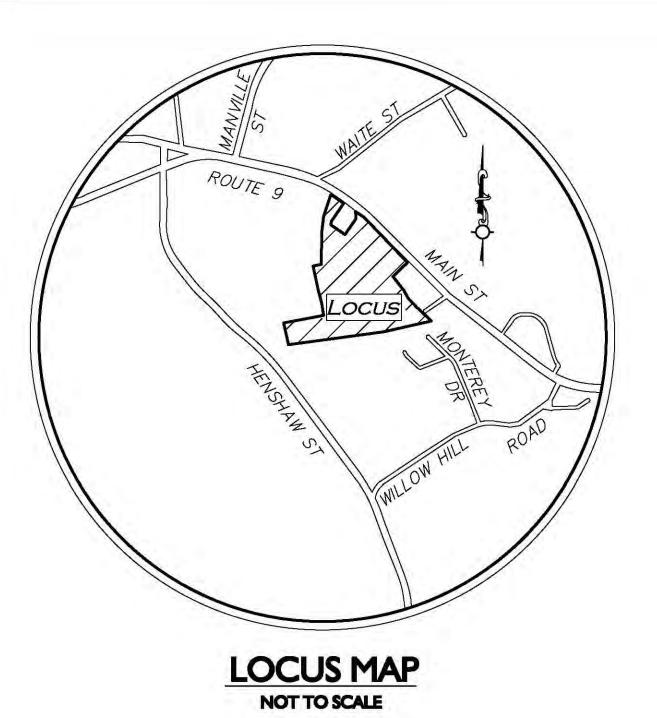

# DEFINITIVE SUBDIVISION PLANS FOR SKYVIEW ESTATES

MAIN STREET LEICESTER, MA 01611

CONDITIONS OF APPROVAL ARE CONTAINED IN THE WRITTEN DECISION OF THE PLANNING BOARD ENTITLED, "CERTIFICATE OF APPROVAL OF A DEFINITIVE SUBDIVISION PLAN" DATED \_\_ 2021 AND RECORDED IN THE WORCESTER DISTRICT REGISTRY OF DEEDS IN BOOK \_\_\_\_\_ PAGE \_\_\_

THE CONSTRUCTION OF WAYS AND INSTALLATION OF SERVICES SHOWN ON THIS PLAN ARE SECURED BY WAY OF A COVENANT, DATED

APPROVAL OF THE LEICESTER PLANNING BOARD IS FOR IN THE EVENT THE WAYS AND SERVICES SHOWN ON THIS PLAN ARE NOT CONSTRUCTED AND INSTALLED WITHIN YEARS \_\_\_\_\_ FROM THE DATE OF ENDORSEMENT, THE BOARD'S APPROVAL IS RESCINDED, AND THIS PLAN IS AND

THE CERTIFICATIONS SHOWN HEREON ARE INTENDED TO MEET THE REGISTRY O DEEDS REQUIREMENTS AND ARE NOT A CERTIFICATION TO THE TITLE OR OWNERSHIP OF THE PROPERTY SHOWN. OWNERS OF ADJOINING PROPERTIES ARE

I CERTIFY THIS PLAN HAS BEEN PREPARED IN CONFORMITY THE THE RULES AND REGULATIONS OF THE REGISTERS OF DEEDS OF THE COMMONWEALTH OF

**ISSUED FOR PLANNING BOARD REVIEW JULY 16, 2021** 

PROFESSIONAL LAND SURVEYOR FOR ALLEN & MAJOR ASSOCIATES, INC.

**AGENT: RE/MAX PATRIOT REALTY 55 MEAD STREET LEOMINSTER, MA 01453** 

**APPLICANT** MKEP 770 LLC 265 SUNRISE HIGHWAY, SUITE 1368 **ROCKVILLE CENTER, NY 11570** 

**OWNER** E F G REALTY TRUST **EDGAR GREENEY, JR - TRUSTEE 76 MCCLELLAN STREET** AMHERST, MA 01002

**CIVIL ENGINEER / SURVEYOR: ALLEN & MAJOR ASSOCIATES, INC.** 100 COMMERCE WAY, SUITE 5 **WOBURN, MA 01801** 

**ENVIRONMENTAL CONSULTANT GOVE ENVIRONMENTAL SERVICES, INC. 8 CONTINENTAL DR BLDG 2 UNIT H EXETER NH 03833-7507** 

#### LEICESTER PLANNING BOARD WAIVERS REQUESTED

SECTION V.A.1.f - MINIMUM CENTER LINE RADII. 200' MIN. REQUIRED TO ALLOW CENTER LINE RADIUS OF 75' AND 100'

SECTION V.A.3.a - MAXIMUM STREET GRADE. 10% TO ALLOW FOR A STREET GRADE OF 14% BETWEEN STA 1+00 & STA 5+00 ALONG ALIGNMENT #9 AND 20% BETWEEN STA 13+50 & STA 16+00 ALONG ALIGNMENT #7

SECTION VI.B.1A -REINFORCED CONCRETE STORM DRAINAGE PIPING REQUIRED A WAIVER IS REQUESTED TO UTILIZE HIGH DENSITY POLYPROPYLENE (HDPE) DRAINAGE LINES OR APPROVED EQUAL WITHIN THE DRAINAGE SYSTEM OF THE SUBDIVISION.

SECTION VI.E.3 - STREET LIGHTING REQUIRED TO ALLOW STREET LIGHTING TO BE INSTALLED AS PRIVATE DRIVEWAY LIGHT

SECTION VI.L STREET TREES SHALL BE INSTALLED ON BOTH SIDES OF THE ROADWAY

TO ALLOW FOR STREET TREE PLANTINGS TO BE INSTALLED ON ONE SIDE ONLY

SECTION VI.G.1 - SIDEWALKS SHALL BE INSTALLED ON BOTH SIDES OF ALL STREETS WITHIN A SUBDIVISION A WAIVER IS REQUESTED TO INSTALL SIDEWALKS ON ONLY 1 SIDE OF THE ROADWAY DUE TO THE STEEP TERRAIN OF THE PROPOSED SUBDIVISION AND LACK OF CONNECTION TO A MUNICIPAL SIDEWALK ALONG MAIN STREET (AKA ROUTE 9)

#### **GENERAL NOTES**

1. THE OWNER OF RECORD:

LOT 21-B5.1 EFG REALTY TRUST 76 MCCLELLAN STREET AMHERST, MA 01002 BOOK 16761, PAGE 78

2. ZONING DISTRICT: BUSINESS (B) AND SUBURBAN AGRICULTURAL (SA) DISTRICT TO THE SOUTH & WEST

LOT SIZE: LOT FRONTAGE: FRONT SETBACK: 25 FT. SIDE SETBACK: 15 FT. REAR SETBACK: 25 FT.

3. EXISTING USE OF LOT 21-B5.1 IS VACANT LAND.

4. NO PORTION OF THE PROPERTY IS WITHIN THE 100 YEAR FLOOD BOUNDARY HAZARD ZONE AS SHOWN ON THE FLOOD INSURANCE RATE MAP #25027C0782E WITH AN EFFECTIVE DATE: JULY 14, 2011 FOR THE CITY OF LEICESTER.

LIST OF DRAWINGS						
DRAWING TITLE	SHEET NO.	ISSUED	REVISED			
EXISTING CONDITIONS	V-101	07-16-21				
SITE PREPARATION PLAN	C-100	07-16-21	-			
SUBDIVISION LAYOUT KEY PLAN	C-101	07-16-21	1.5			
DEFINITIVE LAYOUT PLAN	C-101A	07-16-21	-			
DEFINITIVE LAYOUT PLAN	C-101B	07-16-21	1.87			
DEFINITIVE LAYOUT PLAN	C-101C	07-16-21	1.8/			
OVERALL GRADING & DRAINAGE PLAN	C-102	07-16-21	1.57			
GRADING & DRAINAGE PLAN	C-102A	07-16-21				
GRADING & DRAINAGE PLAN	C-102B	07-16-21				
GRADING & DRAINAGE PLAN	C-102C	07-16-21				
OVERALL UTILITIES PLAN	C-103	07-16-21				
UTILITIES PLAN	C-103A	07-16-21	-			
UTILITIES PLAN	C-103B	07-16-21	- 50			
UTILITIES PLAN	C-103C	07-16-21	1.5			
ROADWAY PROFILES ALIGNMENTS (8) & (9)	C-201	07-16-21				
ROADWAY PROFILES ALIGNMENT (7)	C-202	07-16-21	-1			
DETAILS	C-501	07-16-21	-			
DETAILS	C-502	07-16-21				
DETAILS	C-503	07-16-21				

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BE RECORDED HEREWITH.
DATE:
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A SERVICE OF DESCRIPTION
LEICESTER PLANNING BOARD
I CERTIFY THAT NO NOTICE OF APPEAL WAS RECEIVED DURING THE TWENTY (2 RECORDING DAYS NEXT AFTER RECEIPT AND OF NOTICE FROM THE PLANNING BOARD OF THE APPROVAL OF THIS PLANTING THE APPROVAL OF TH
TOWN CLERK - TOWN OF LEICESTER
ISSUED FOR
PLANNING BOARD REVIEW
JULY 16, 2021
PROFESSIONAL ENGINEER FOR
ALLEN & MAJOR ASSOCIATES, INC.

AP	PLICANT:
	MKEP 770 LLC
	265 SUNRISE HIGHWAY, SUITE 136
	ROCKVILLE CENTER, NY 11570
PR	ROJECT:
	SKYVIEW ESTATES
	RESIDENTIAL SUBDIVISION

REV DATE DESCRIPTION

LEICESTER, MA						
PROJECT NO.	2889-01	DATE:	07-16-2			
SCALE:	1" = ##'	DWG. : C-28	389-01_Cove			

SM CHECKED BY:

MAIN STREET

ALLEN & MAJOR ASSOCIATES, INC.

environmental consulting • landscape architecture www.allenmajor.com 100 COMMERCE WAY, SUITE 5 WOBURN MA 01801 TEL: (781) 935-6889

FAX: (781) 935-2896 WOBURN, MA ◆ LAKEVILLE, MA ◆ MANCHESTER, NI

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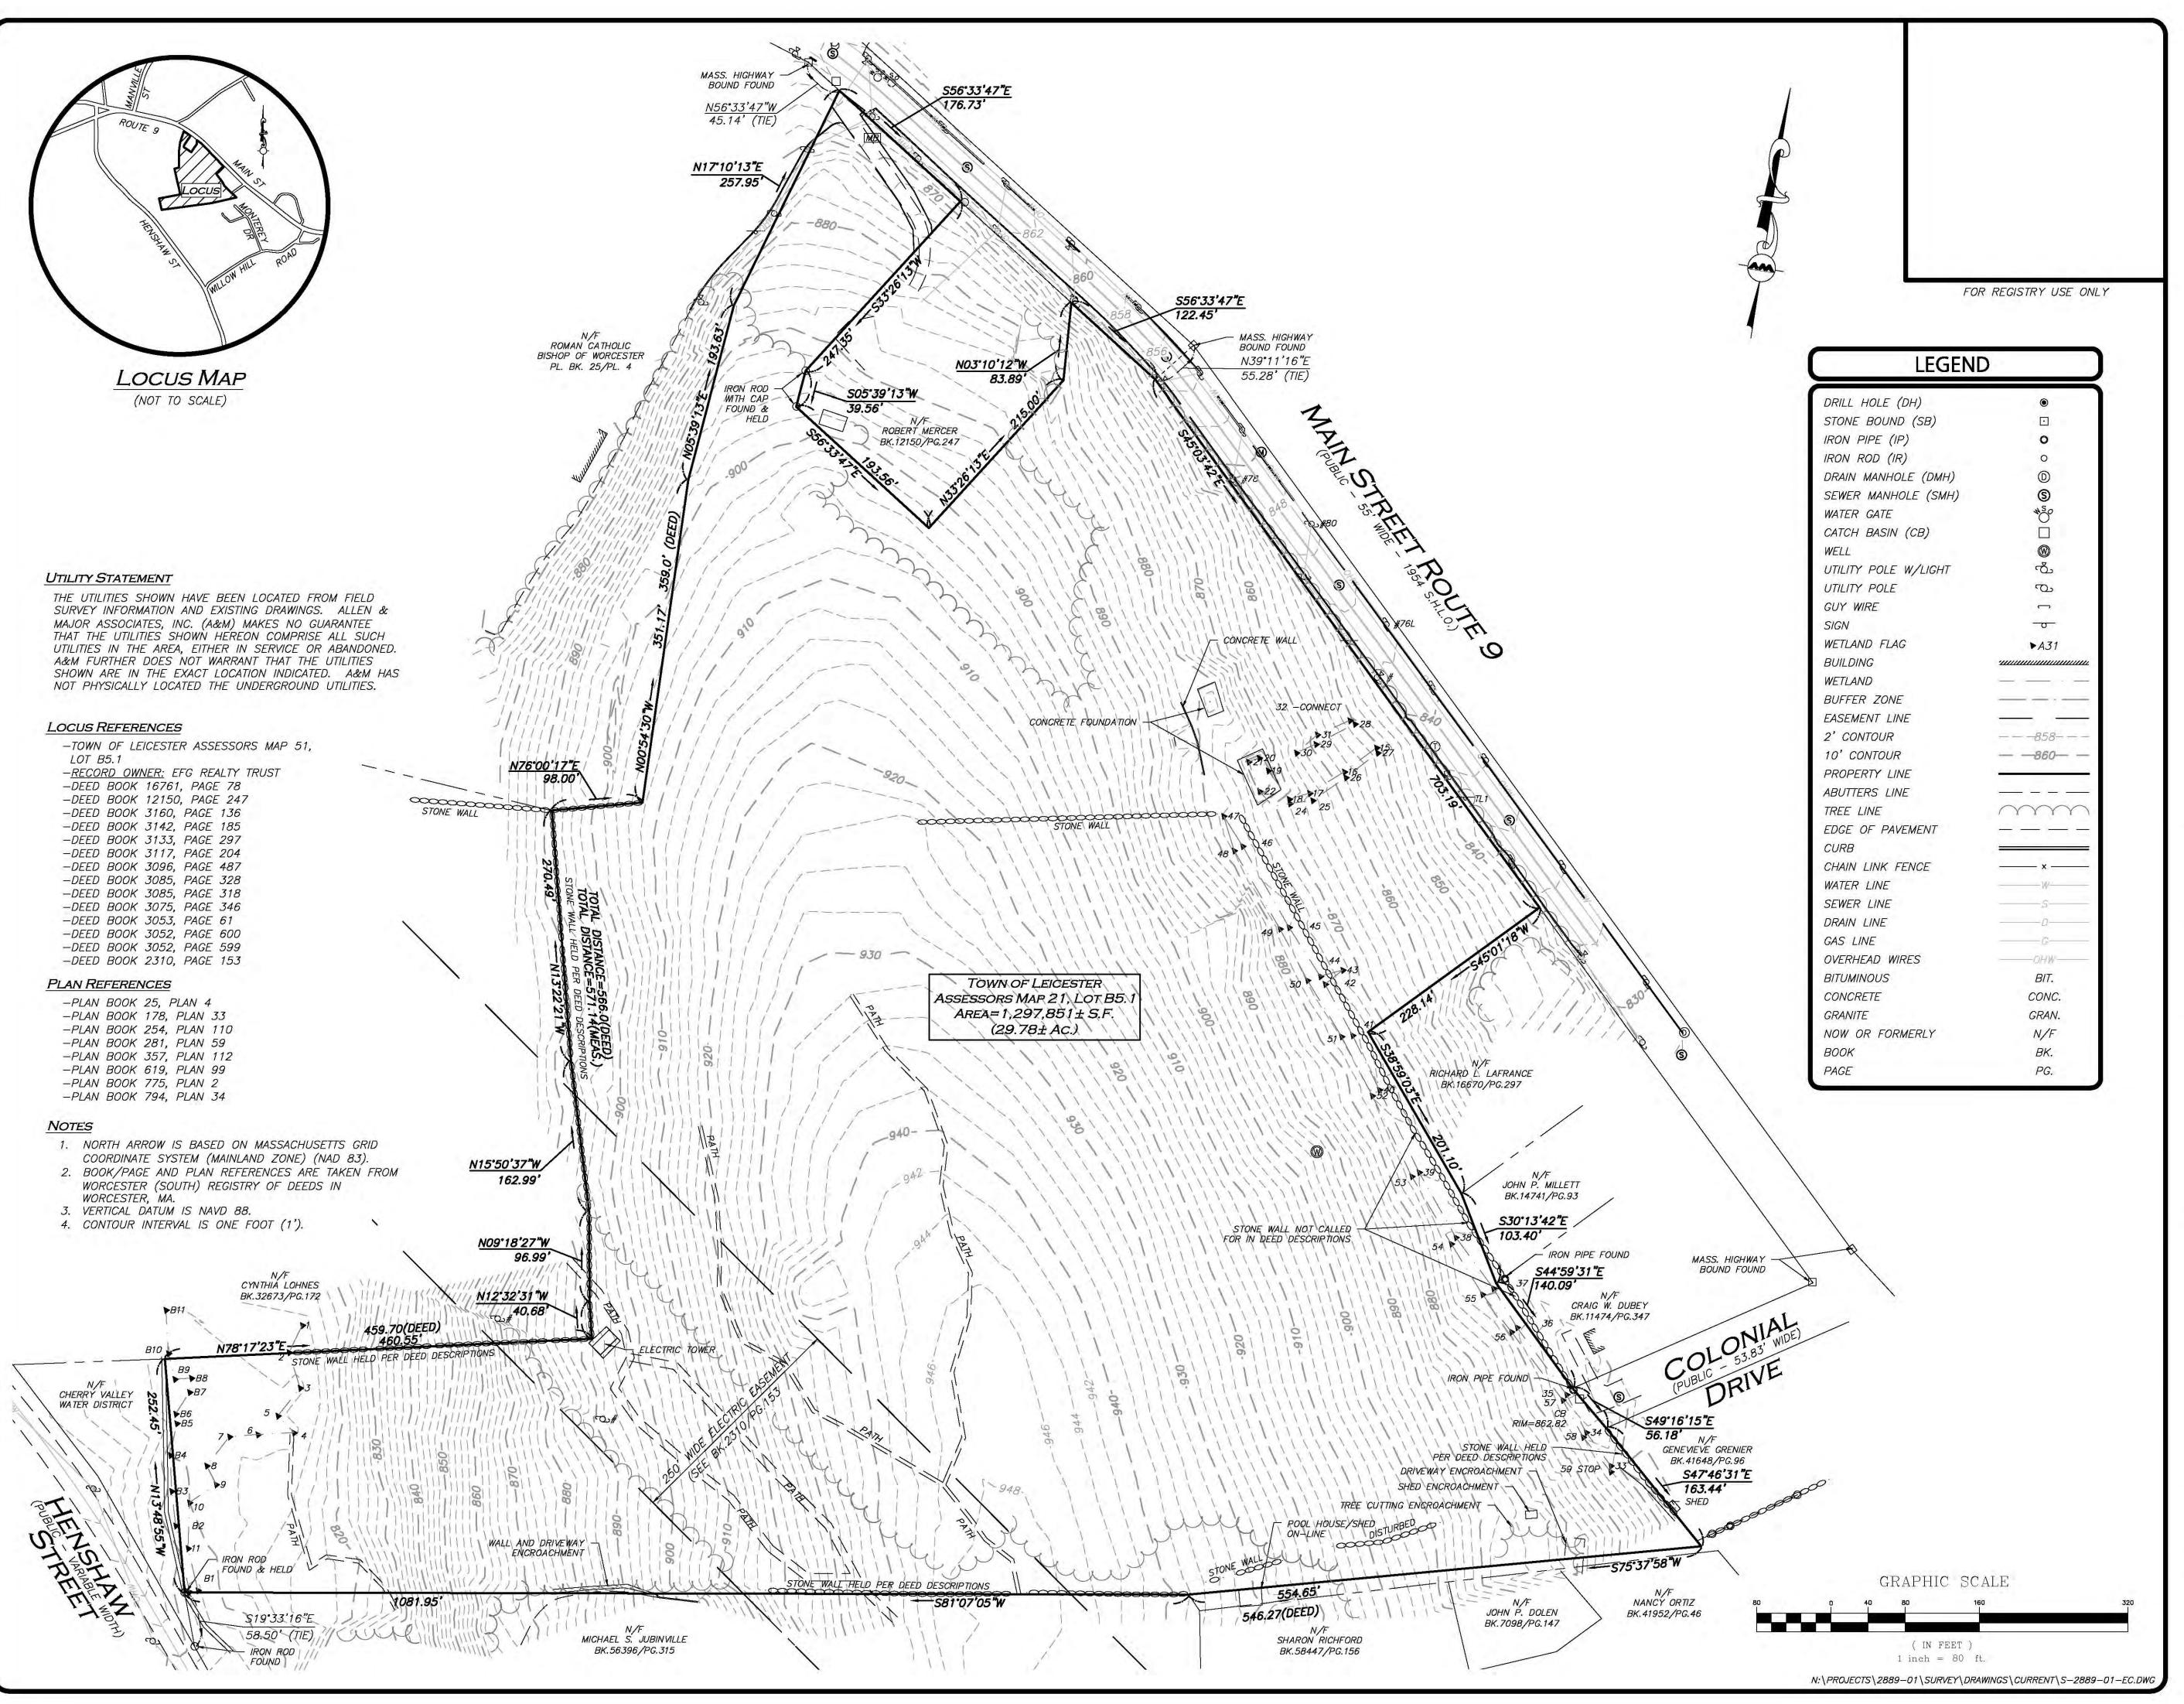
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SHEET No.

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ISSUED FOR DEFINITIVE SUBDIVISION: JULY 16, 2021



WE HEREBY CERTIFY THAT:

THIS PLAN IS THE RESULT OF AN ACTUAL ON THE GROUND SURVEY PERFORMED ON OR BETWEEN JANUARY 10, 2021 AND FEBRUARY 9, 2021.

THIS PLAN WAS PREPARED IN ACCORDANCE WITH THE RULES AND REGULATIONS OF THE REGISTERS OF DEEDS DATED JANUARY 1, 1976 AND REVISED JANUARY 12, 1988.
ACCORDING TO DEEDS AND PLANS OF RECORD, THE PROPERTY LINES SHOWN ON THIS PLAN ARE THE LINES DIVIDING EXISTING OWNERSHIP, AND THE LINES OF THE STREETS OR WAYS SHOWN ARE THOSE OF PUBLIC OR PRIVATE STREETS AND WAYS ALREADY ESTABLISHED, AND THAT NO NEW LINES FOR THE DIVISION OF EXISTING OWNERSHIP OR FOR NEW WAYS ARE SHOWN.

THE ABOVE CERTIFICATION IS INTENDED TO MEET REGISTRY OF DEEDS REQUIREMENTS FOR THE RECORDING OF PLANS AND IS NOT A CERTIFICATION TO THE TITLE OR OWNERSHIP OF THE PROPERTY SHOWN. OWNERS OF ADJOINING PROPERTIES ARE SHOWN ACCORDING TO CURRENT TOWN OF LEICESTER

ASSESSOR'S INFORMATION.

THE ABOVE IS CERTIFIED TO THE BEST OF
MY PROFESSIONAL KNOWLEDGE, INFORMATION
AND BELIEF.

ALLEN & MAJOR ASSOCIATES, INC.

PROFESSIONAL LAND SURVEYOR FOR ALLEN & MAJOR ASSOCIATES, INC.

REV DATE DESCRIPTION

APPLICANT:

MKEP 770 LLC 265 SUNRISE HIGHWAY, SUITE 1368 ROCKVILLE CENTER, NY 11570

PROJECT:

651 MAIN STREET LEICESTER, MA

 PROJECT NO.
 2889-01
 DATE:
 03/08/21

 SCALE:
 1" = 80'
 DWG. NAME:
 S-2889-01-EC

 DRAFTED BY:
 AJR
 CHECKED BY:
 NIL

PREPARED BY:



civil engineering • land surveying environmental consulting • landscape architecture www.allenmajor.com 100 COMMERCE WAY

100 COMMERCE WAY WOBURN MA 01801-8501 TEL: (781) 935-6889 FAX: (781) 935-2896

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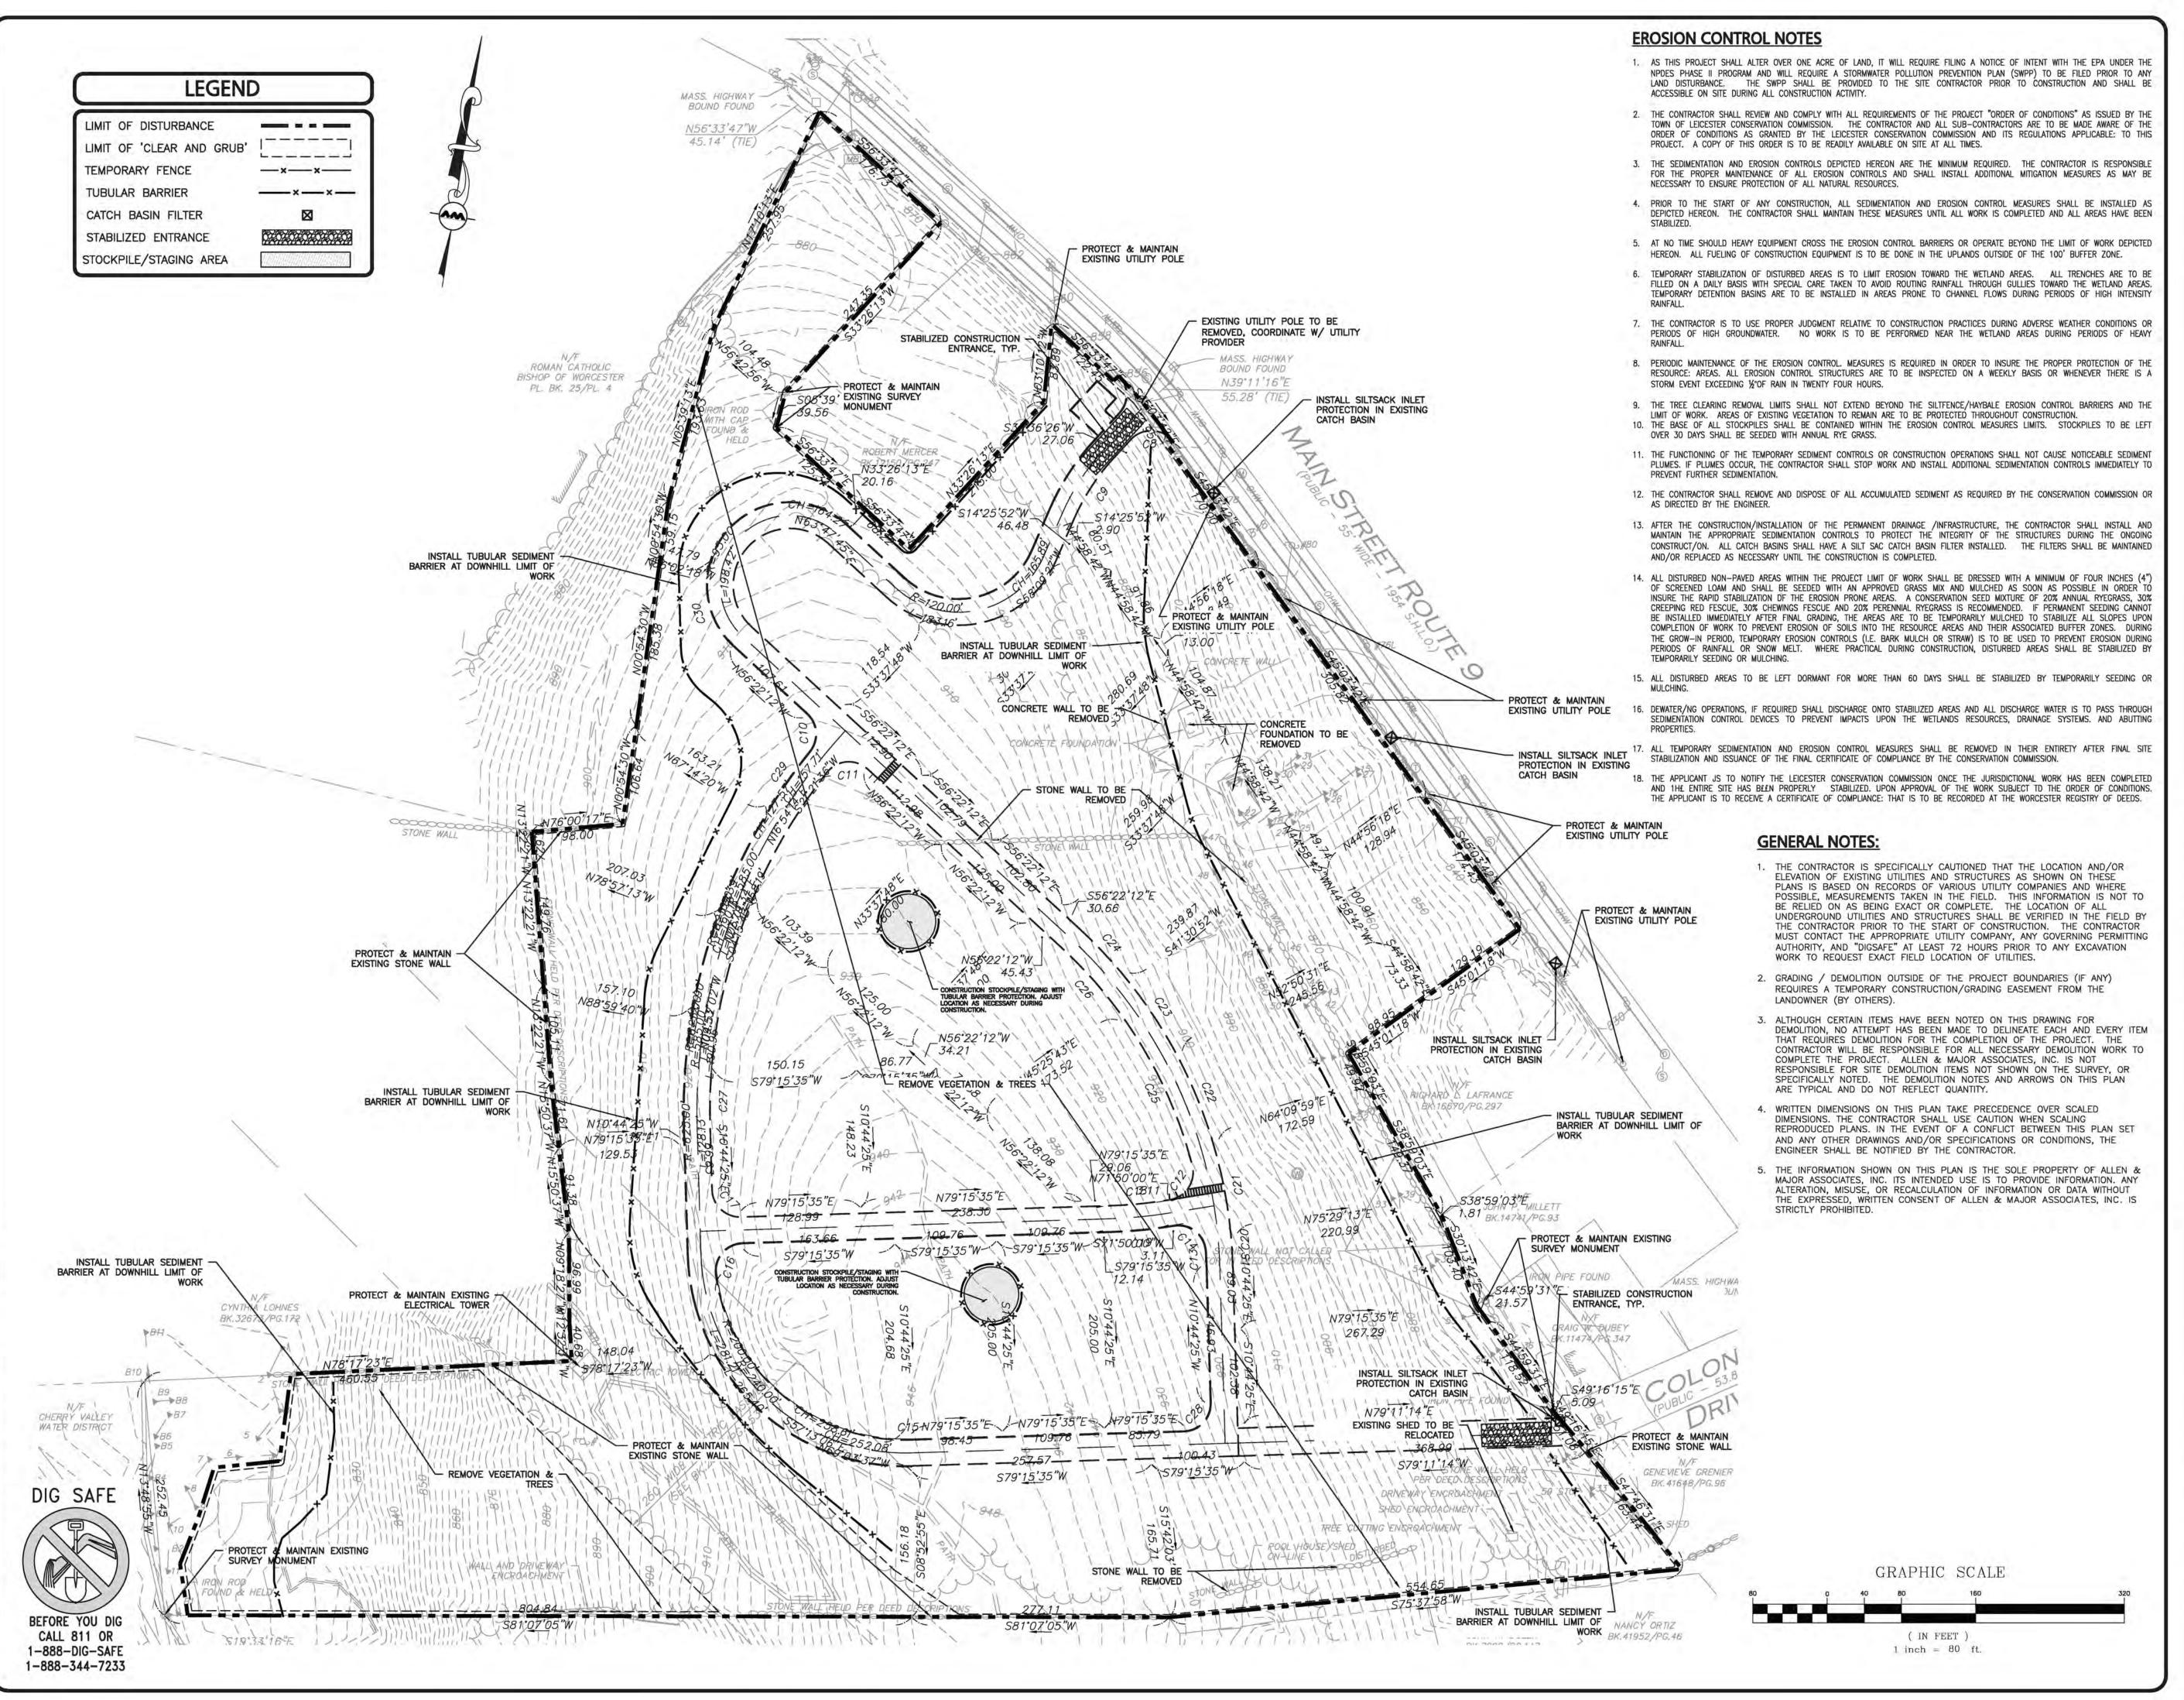
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1 OF 19

SHEET No.



APPROVAL UNDER SUBDIVISION CONTROL REQUIRED. SUBJECT TO A COVENANT TO BE RECORDED HEREWITH.
DATE:

LEICESTER PLANNING BOARD

I CERTIFY THAT NO NOTICE OF APPEAL WAS RECEIVED DURING THE TWENTY (20) RECORDING DAYS NEXT AFTER RECEIPT AND OF NOTICE FROM THE PLANNING BOARD OF THE APPROVAL OF THIS PLAN

TOWN CLERK - TOWN OF LEICESTER

#### **ISSUED FOR** PLANNING BOARD REVIEW **JULY 16, 2021**

PROFESSIONAL ENGINEER FOR ALLEN & MAJOR ASSOCIATES, INC.

ESCRIPTION	

#### APPLICANT:

MKEP 770 LLC 265 SUNRISE HIGHWAY, SUITE 1368 **ROCKVILLE CENTER, NY 11570** 

PROJECT:

SKYVIEW ESTATES **RESIDENTIAL SUBDIVISION** MAIN STREET LEICESTER, MA

2889-01 DATE: PROJECT NO. 07-16-21 SCALE: 1" = 80' DWG. : C-2889-01\_Site-Prep **DESIGNED BY:** SM CHECKED BY:

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ASSOCIATES, INC. civil engineering . land surveying environmental consulting • landscape architecture

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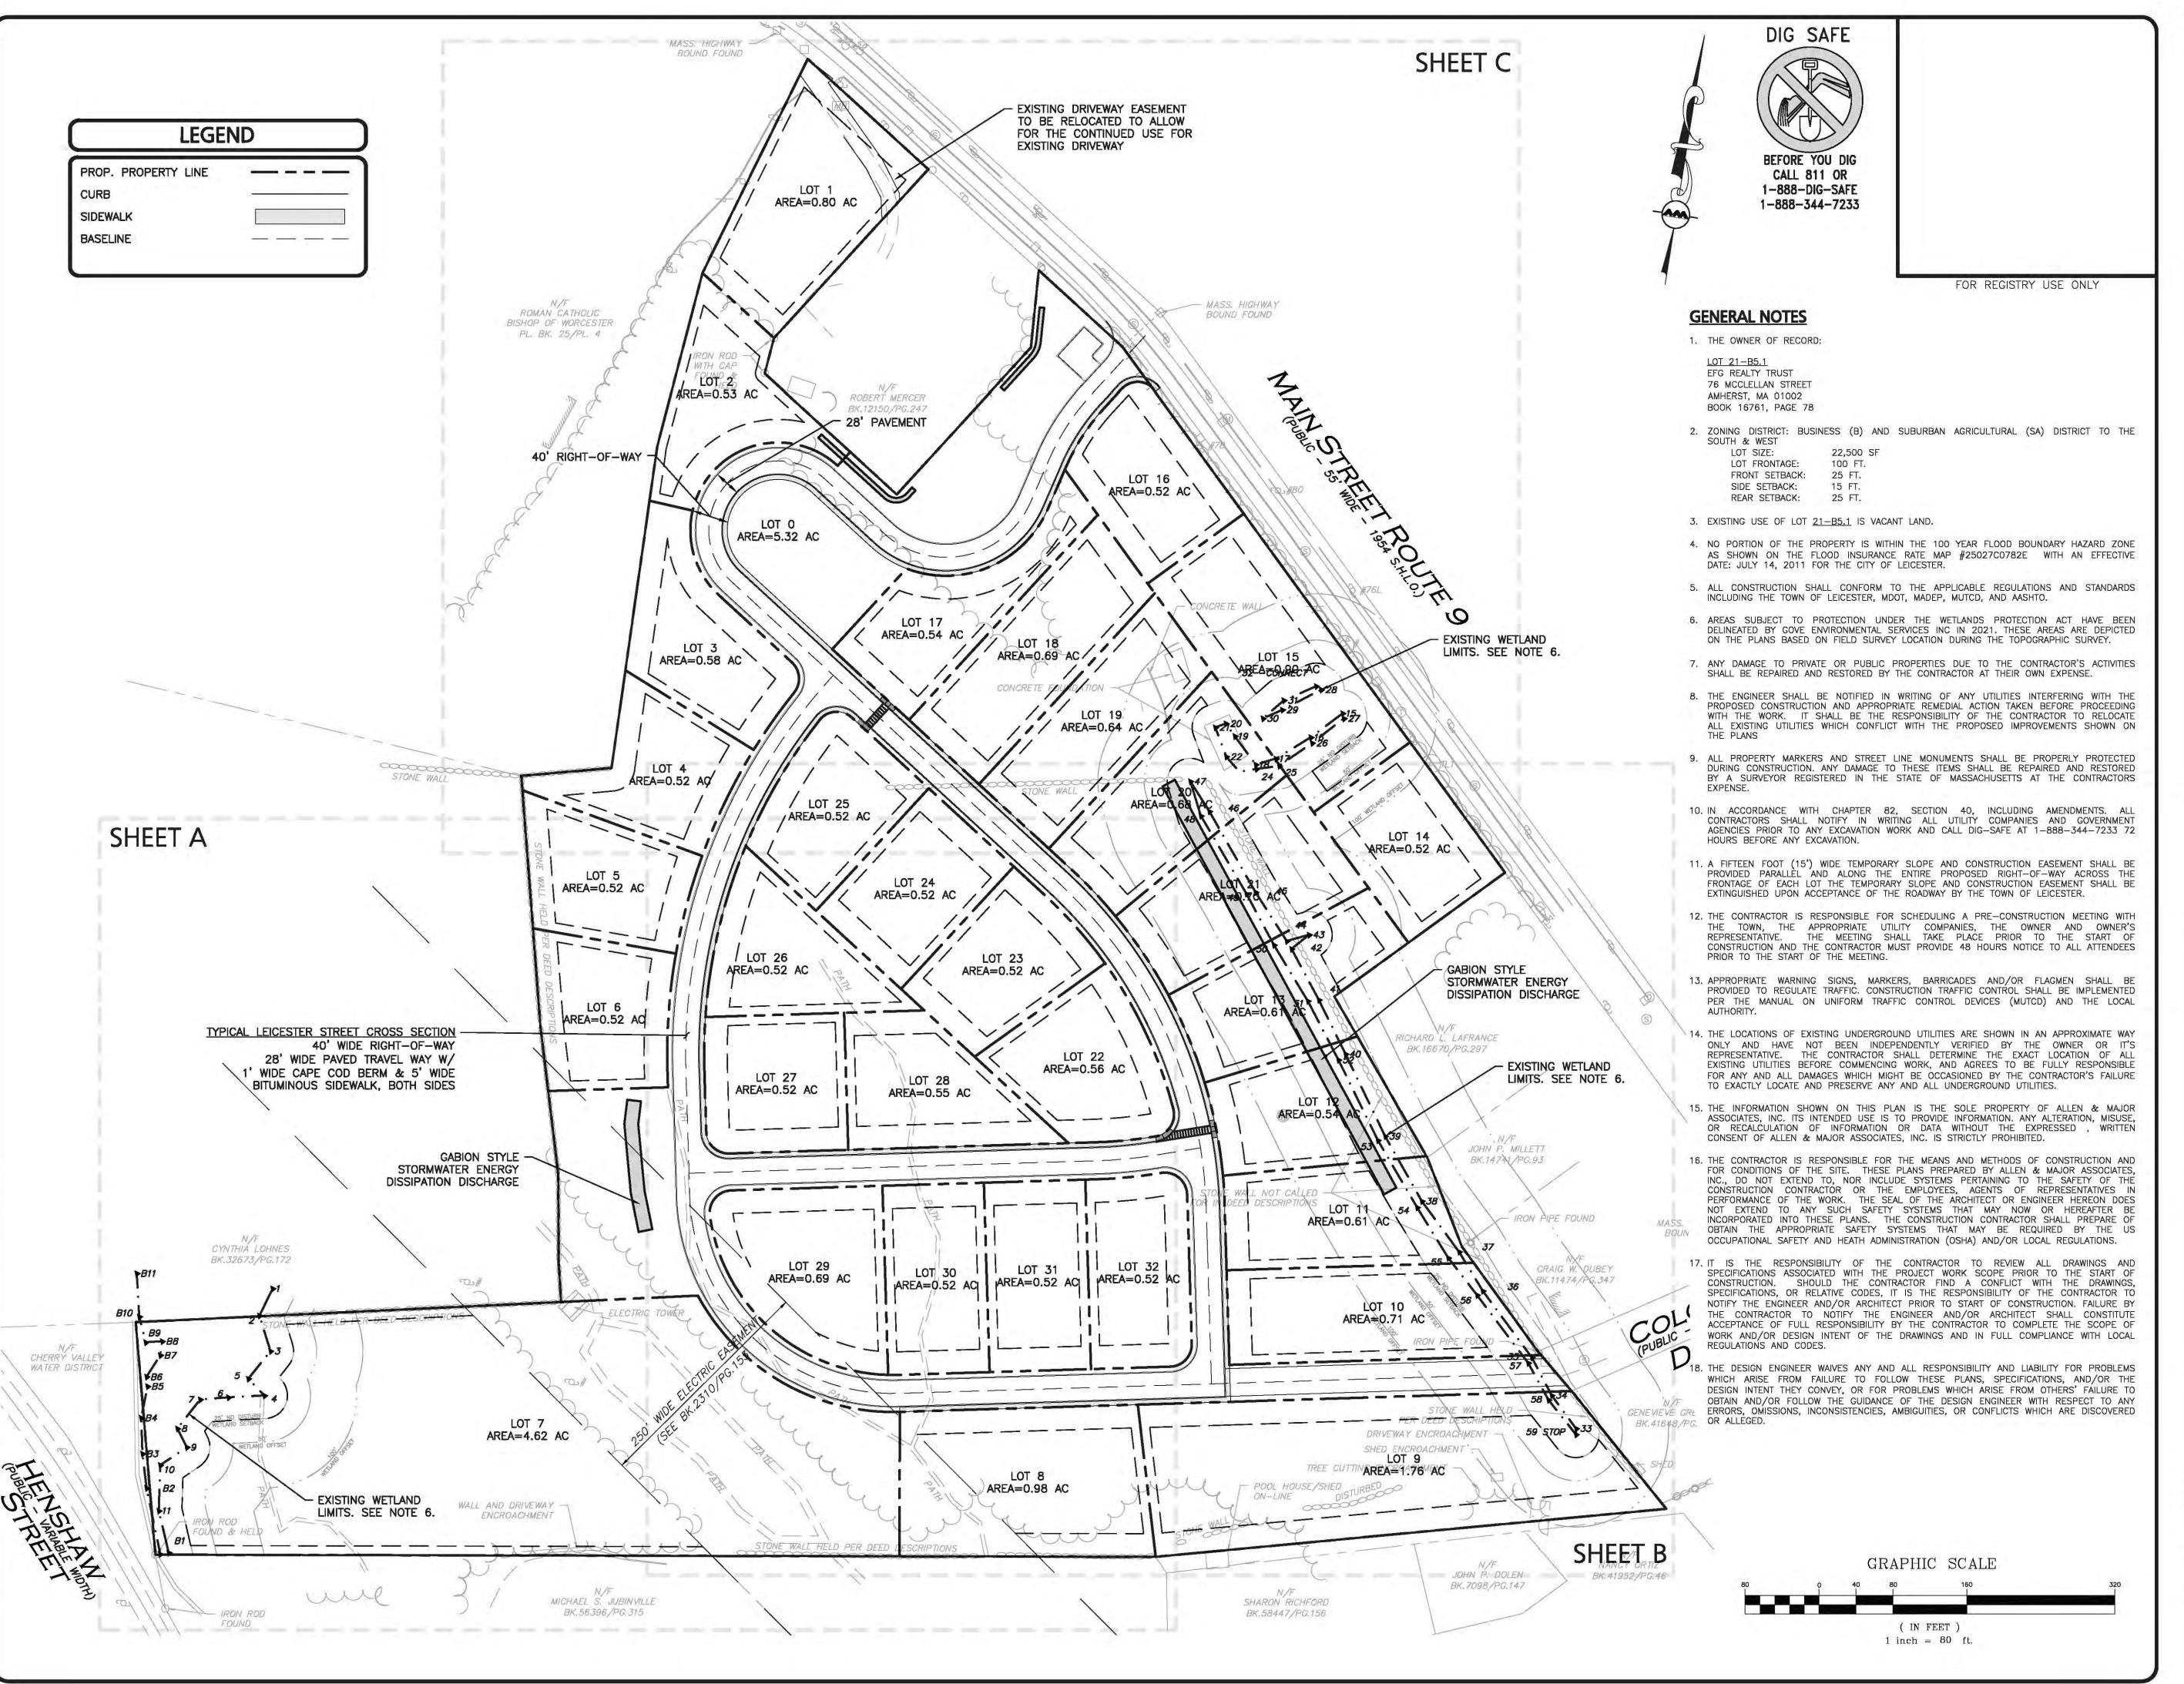
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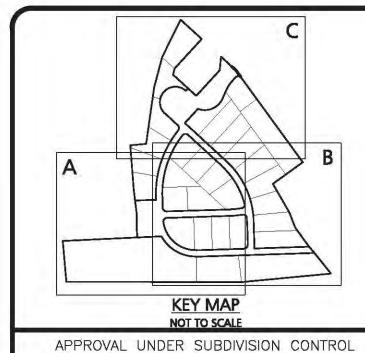
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DRAWING TITLE: SHEET No. C-100 SITE PREPARATION PLAN

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TOWN CLERK - TOWN OF LEICESTER

#### ISSUED FOR PLANNING BOARD REVIEW JULY 16, 2021

PROFESSIONAL ENGINEER FOR ALLEN & MAJOR ASSOCIATES, INC.

		100000000000000000000000000000000000000	
REV	DATE	DESCRIPTION	

APPLICANT:

MKEP 770 LLC 265 SUNRISE HIGHWAY, SUITE 1368 ROCKVILLE CENTER, NY 11570

PROJECT:

SKYVIEW ESTATES
RESIDENTIAL SUBDIVISION
MAIN STREET
LEICESTER, MA

PROJECT NO.	2889-01	DATE: 07-16
SCALE:	1" - 80'	DWG.: C-2889-01_Layout & Mate

DESIGNED BY:
PREPARED BY:



SM CHECKED BY:

ASSOCIATES, INC.

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environmental consulting • landscape architecture

mental consulting ◆ landscape architectu w w w . a l l e n m a j o r . c o m 100 COMMERCE WAY, SUITE 5 WOBURN MA 01801 TEL: (781) 935-6889 FAX: (781) 935-2896

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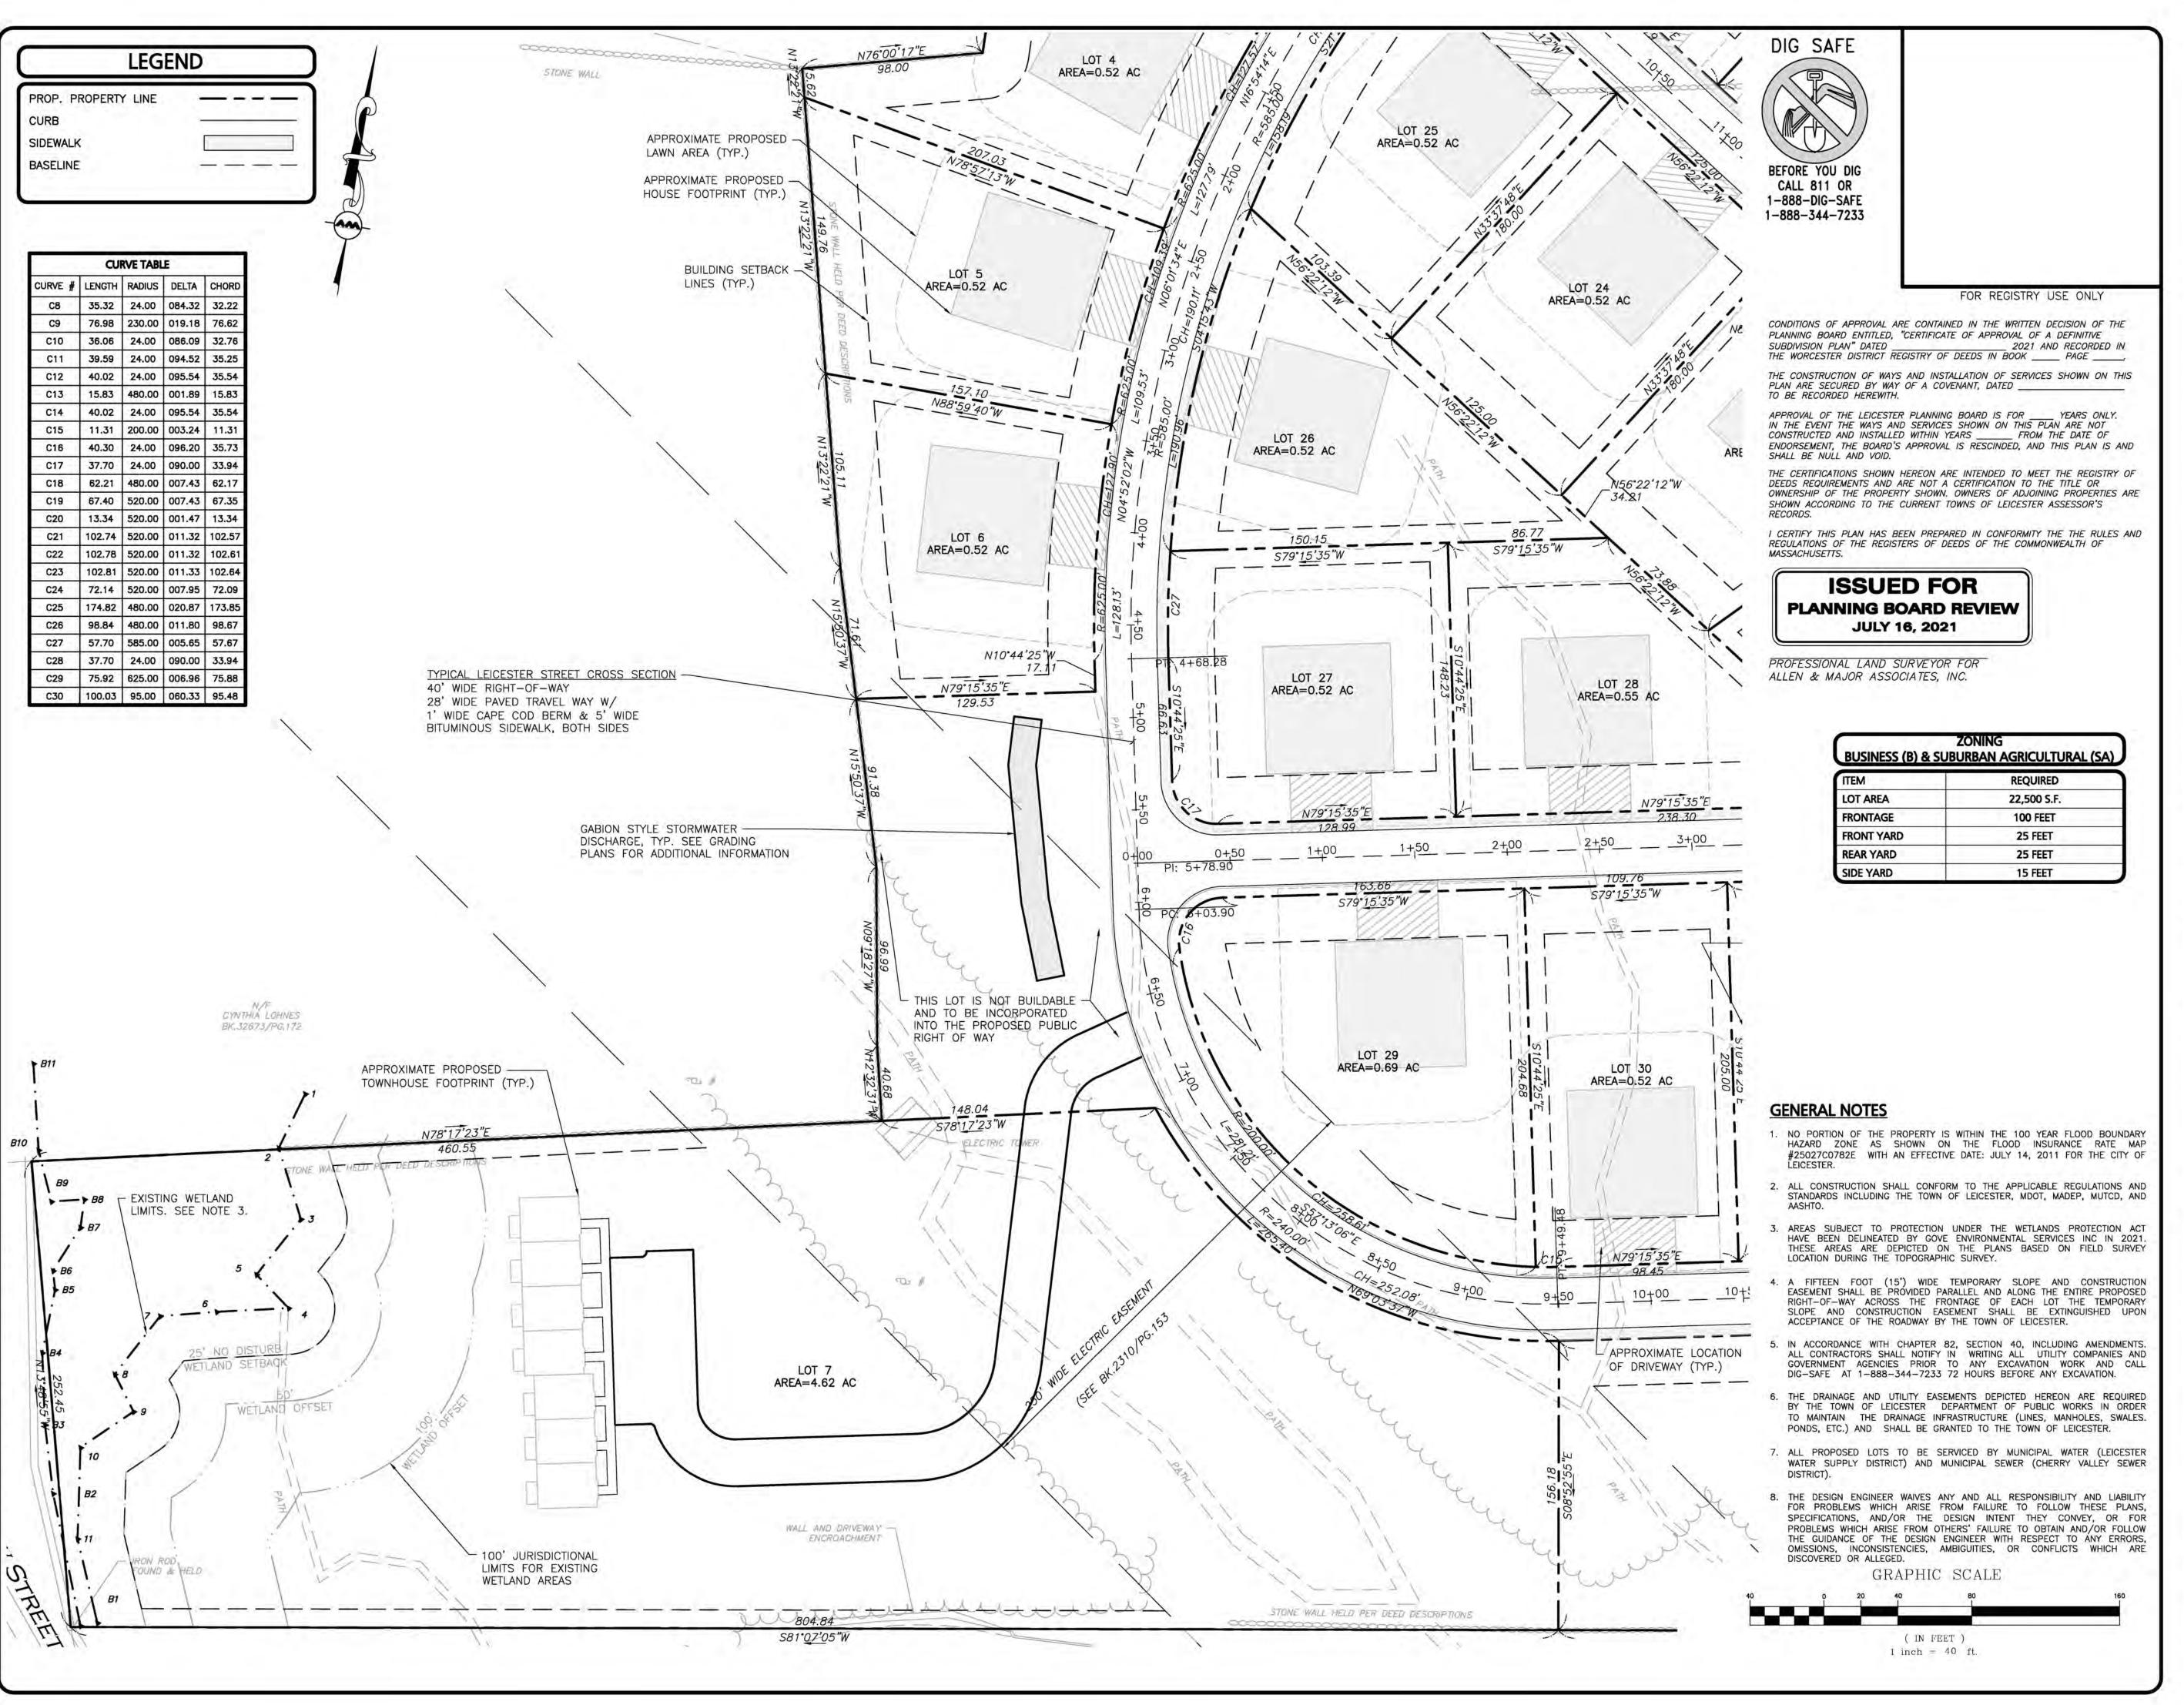
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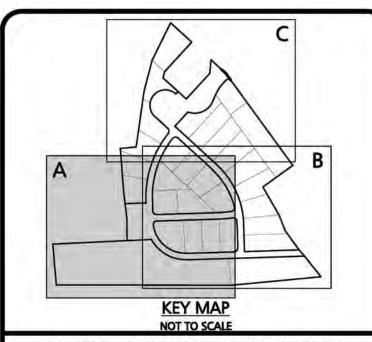
DEFINITIVE SUBDIVISION KEY PLAN

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3 OF 19

C-101





LEICESTER PLANNING BOARD

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TOWN CLERK - TOWN OF LEICESTER

### ISSUED FOR PLANNING BOARD REVIEW JULY 16, 2021

PROFESSIONAL ENGINEER FOR ALLEN & MAJOR ASSOCIATES, INC.

ADDI ICAN	T.		
REV	DATE	DESCRIPTION	

APPLICANT:

MKEP 770 LLC 265 SUNRISE HIGHWAY, SUITE 1368 ROCKVILLE CENTER, NY 11570

PROJECT:

SKYVIEW ESTATES
RESIDENTIAL SUBDIVISION
MAIN STREET
LEICESTER, MA

PROJECT NO. 2889-01 DATE: 07-16-21

SCALE: 1" = 40' DWG. : C-2889-01\_Layout & Materials

SM CHECKED BY:

PREPARED BY:

**DESIGNED BY:** 



### ASSOCIATES, INC.

environmental consulting • landscape architecture
w w w . a l l e n m a j o r . c o m

100 COMMERCE WAY, SUITE 5

WOBURN MA 01801
TEL: (781) 935-6889

FAX: (781) 935-2896

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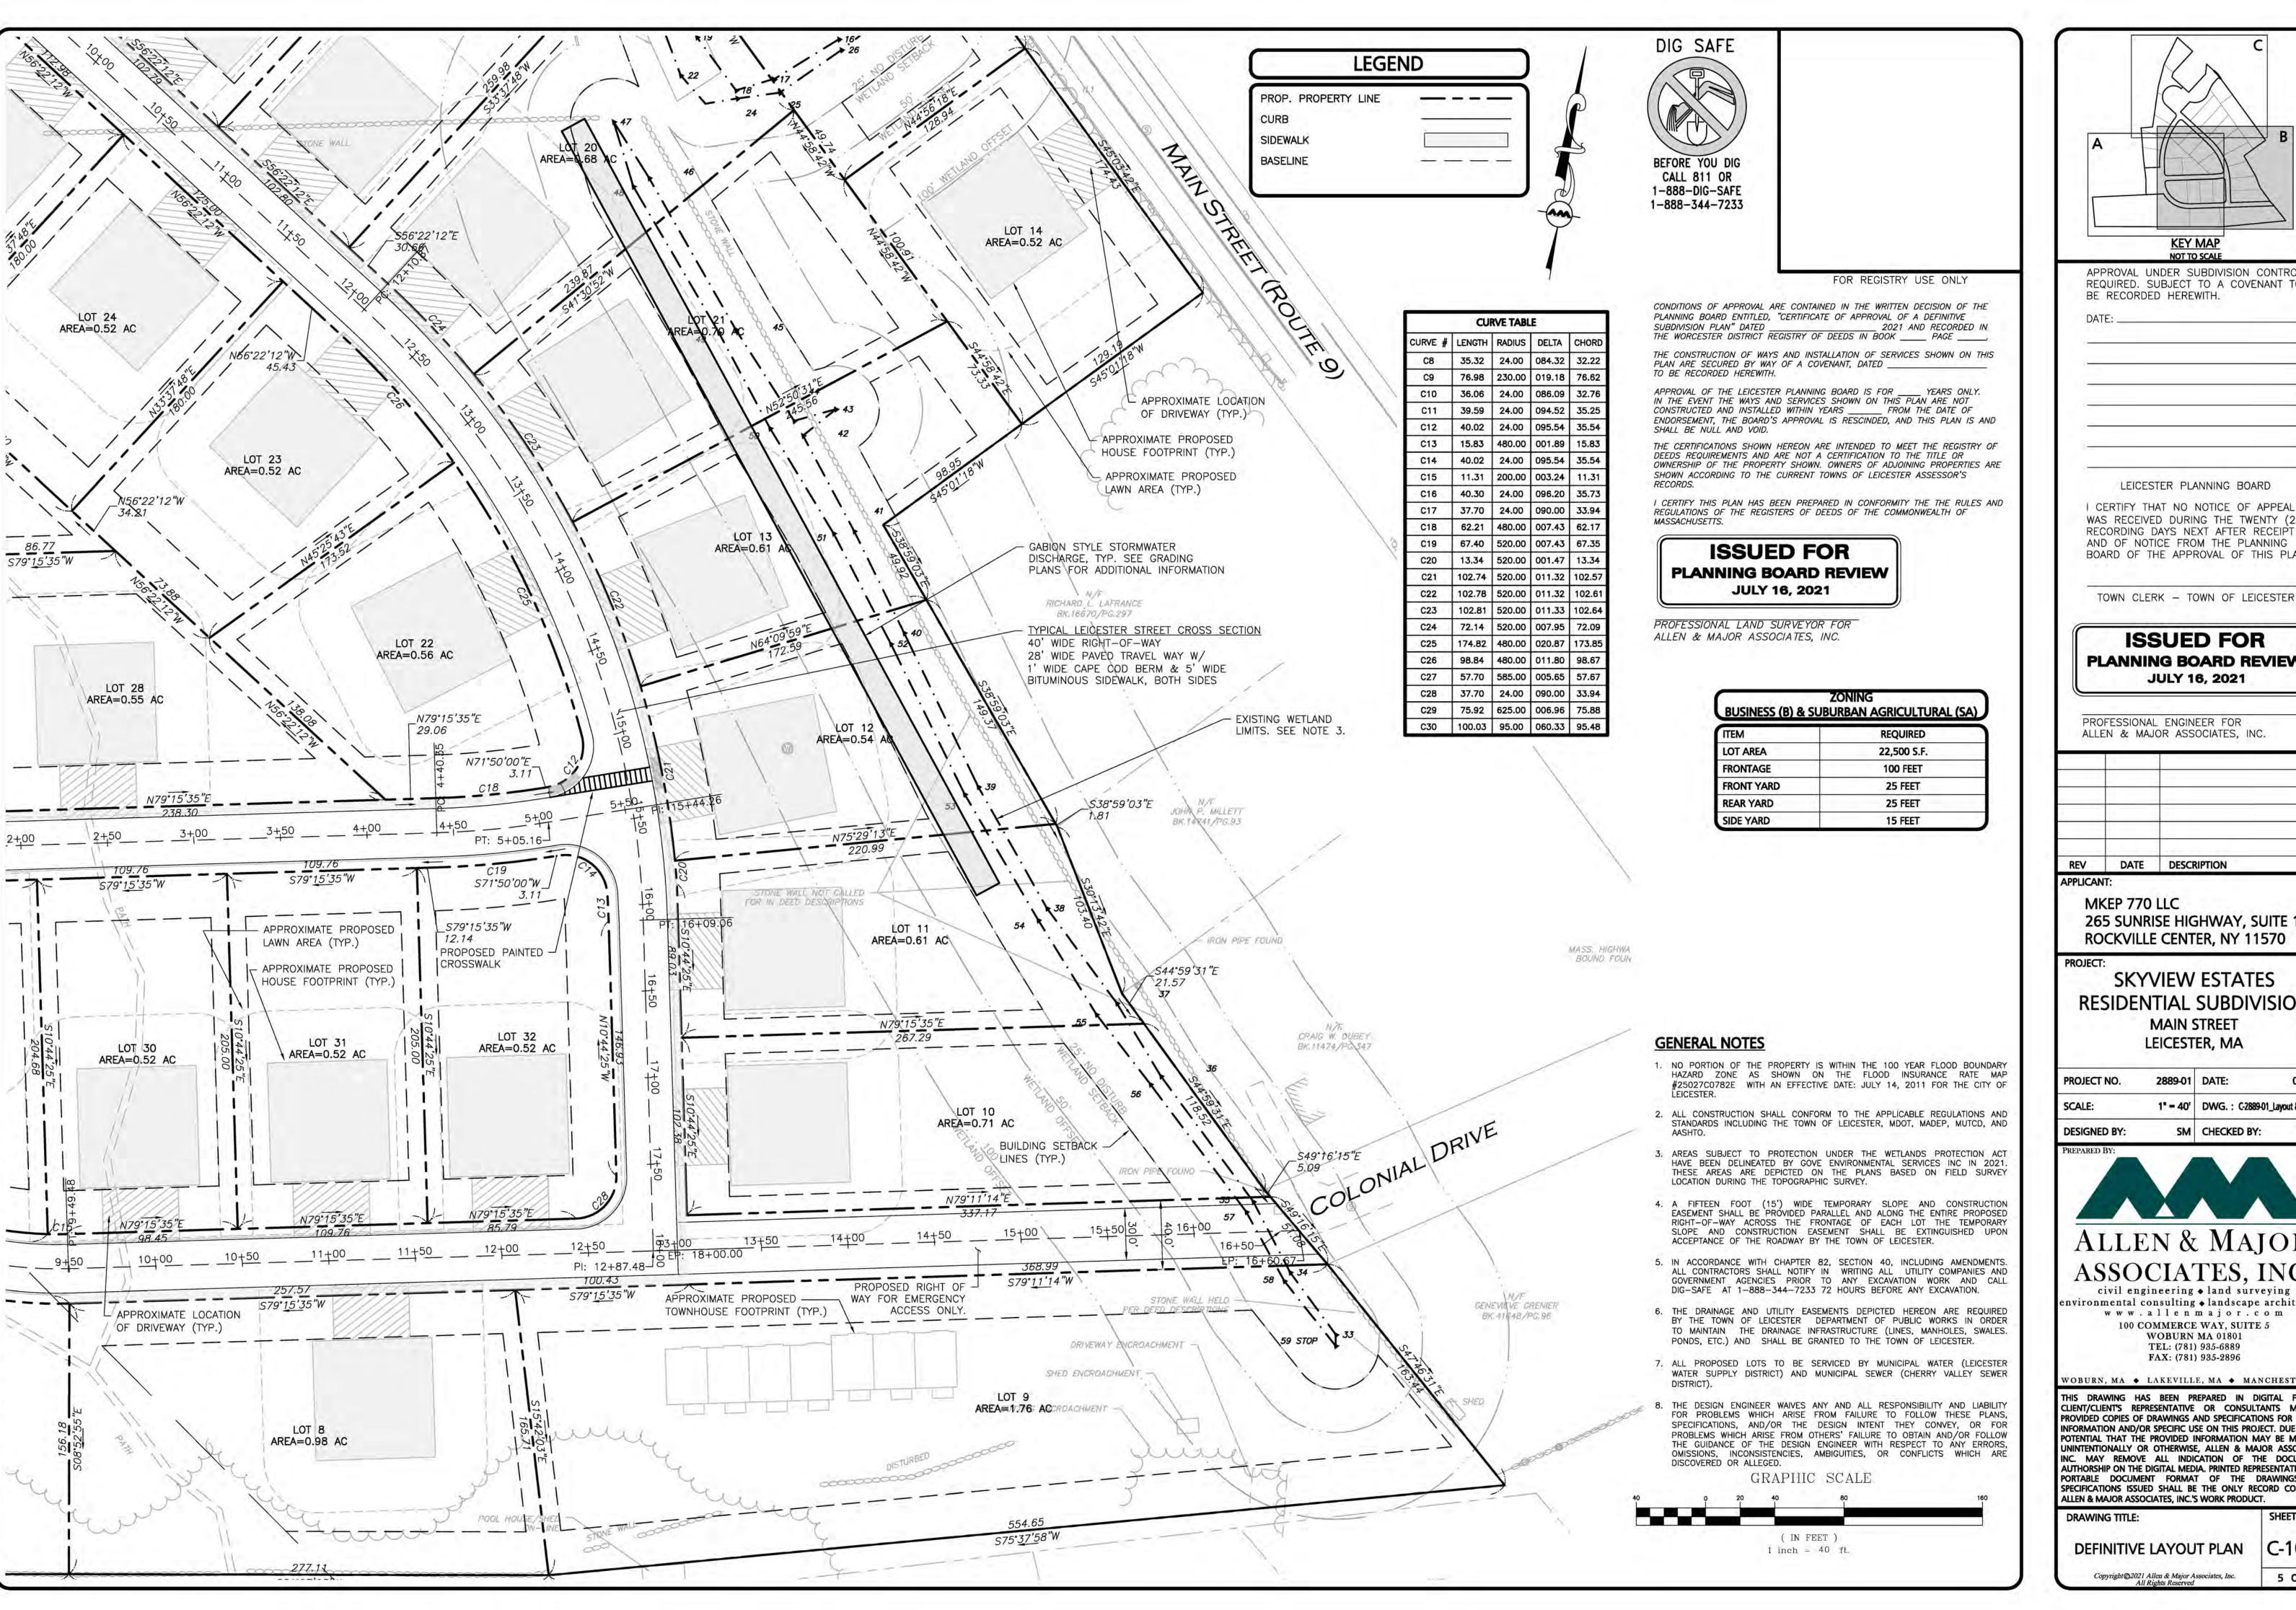
DEFINITIVE LAYOUT PLAN C-101A

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WAS RECEIVED DURING THE TWENTY (20) RECORDING DAYS NEXT AFTER RECEIPT AND OF NOTICE FROM THE PLANNING BOARD OF THE APPROVAL OF THIS PLAN

TOWN CLERK - TOWN OF LEICESTER

#### **ISSUED FOR PLANNING BOARD REVIEW JULY 16, 2021**

PROFESSIONAL ENGINEER FOR ALLEN & MAJOR ASSOCIATES, INC.

		Ti.
REV	DATE	DESCRIPTION

MKEP 770 LLC 265 SUNRISE HIGHWAY, SUITE 1368 **ROCKVILLE CENTER, NY 11570** 

**SKYVIEW ESTATES RESIDENTIAL SUBDIVISION MAIN STREET** LEICESTER, MA

PROJECT NO.	2889-01	DATE:	07-16-21
SCALE:	1" = 40'	DWG. : C-2889-01_La	yout & Materials
DESIGNED BY:	SM	CHECKED BY:	MAM



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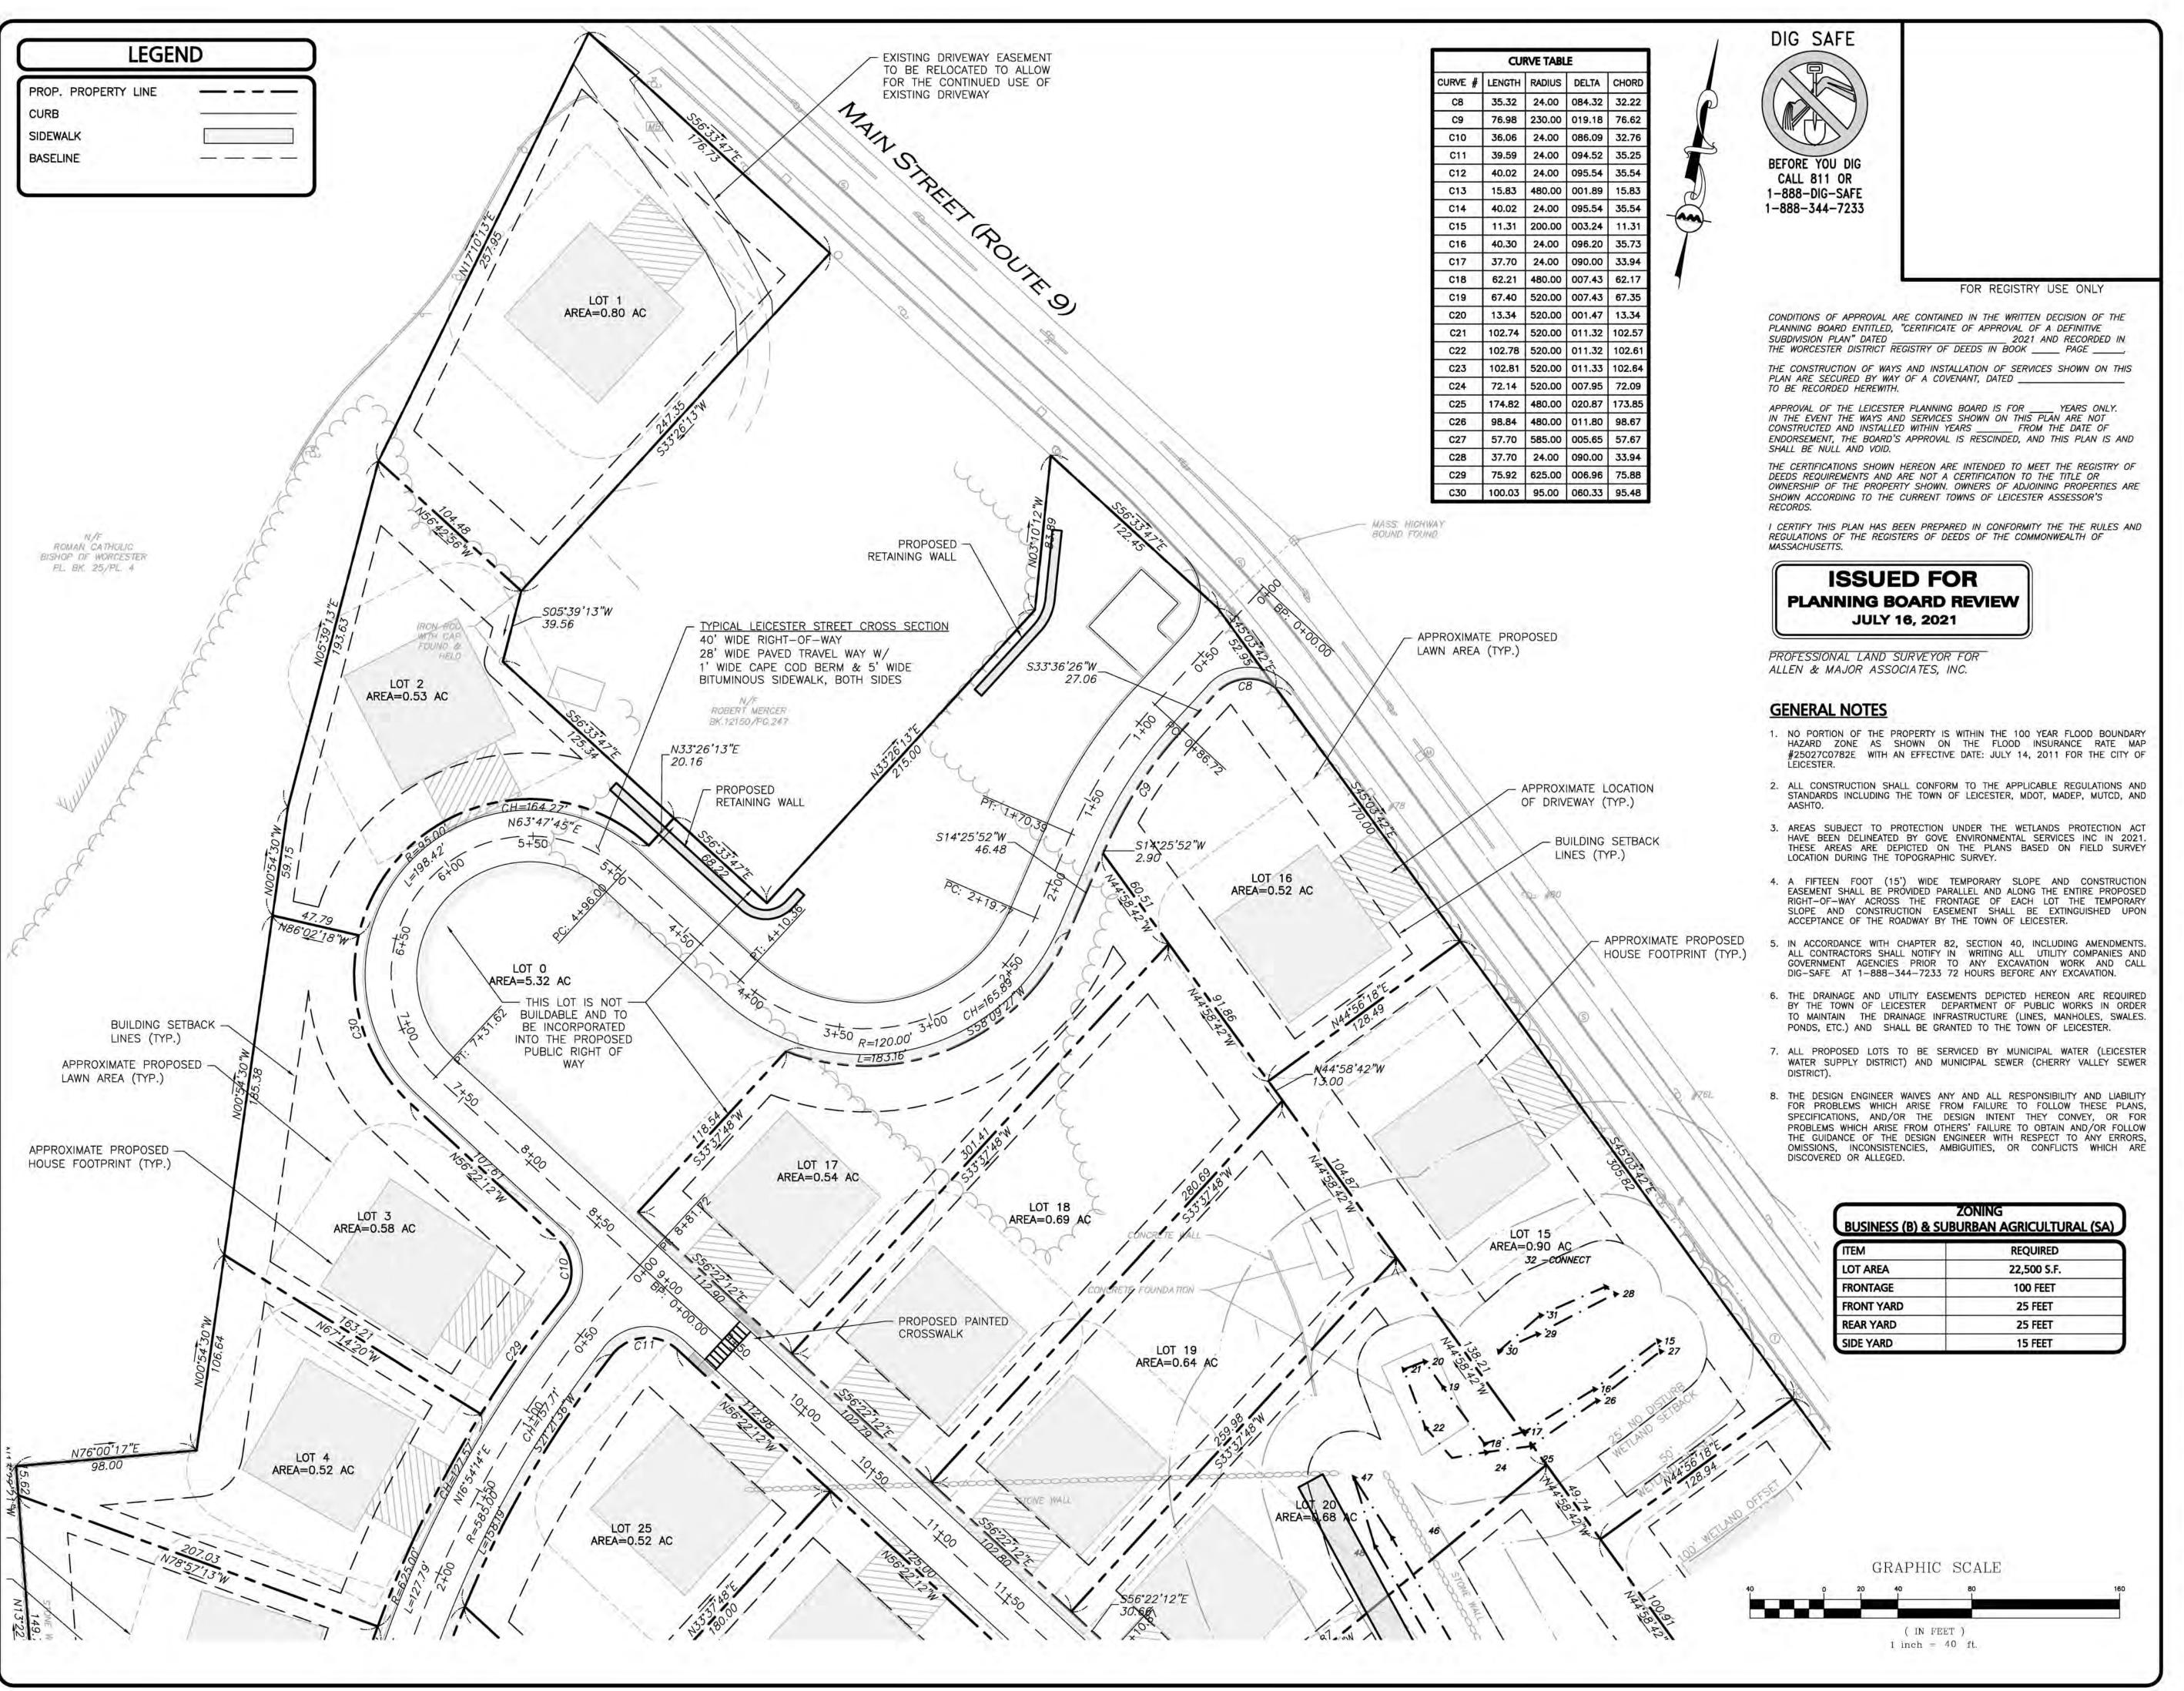
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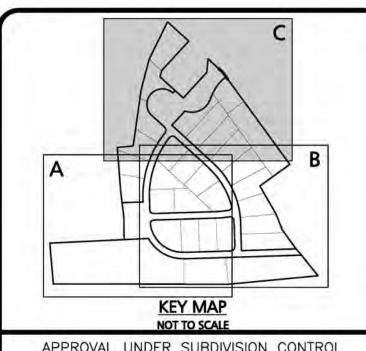
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5 OF 19





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TOWN CLERK - TOWN OF LEICESTER

#### **ISSUED FOR PLANNING BOARD REVIEW JULY 16, 2021**

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REV	DATE	DESCRIPTION	

MKEP 770 LLC 265 SUNRISE HIGHWAY, SUITE 1368 **ROCKVILLE CENTER, NY 11570** 

PROJECT:

**SKYVIEW ESTATES RESIDENTIAL SUBDIVISION** MAIN STREET LEICESTER, MA

	PROJECT NO.	2889-01	DATE:	07-16-2
	SCALE:	1" = 40'	DWG. : C-2889-01_L	ayout & Material
	DESIGNED BY:	SM	CHECKED BY:	MAN
ì	PREPARED BY:			



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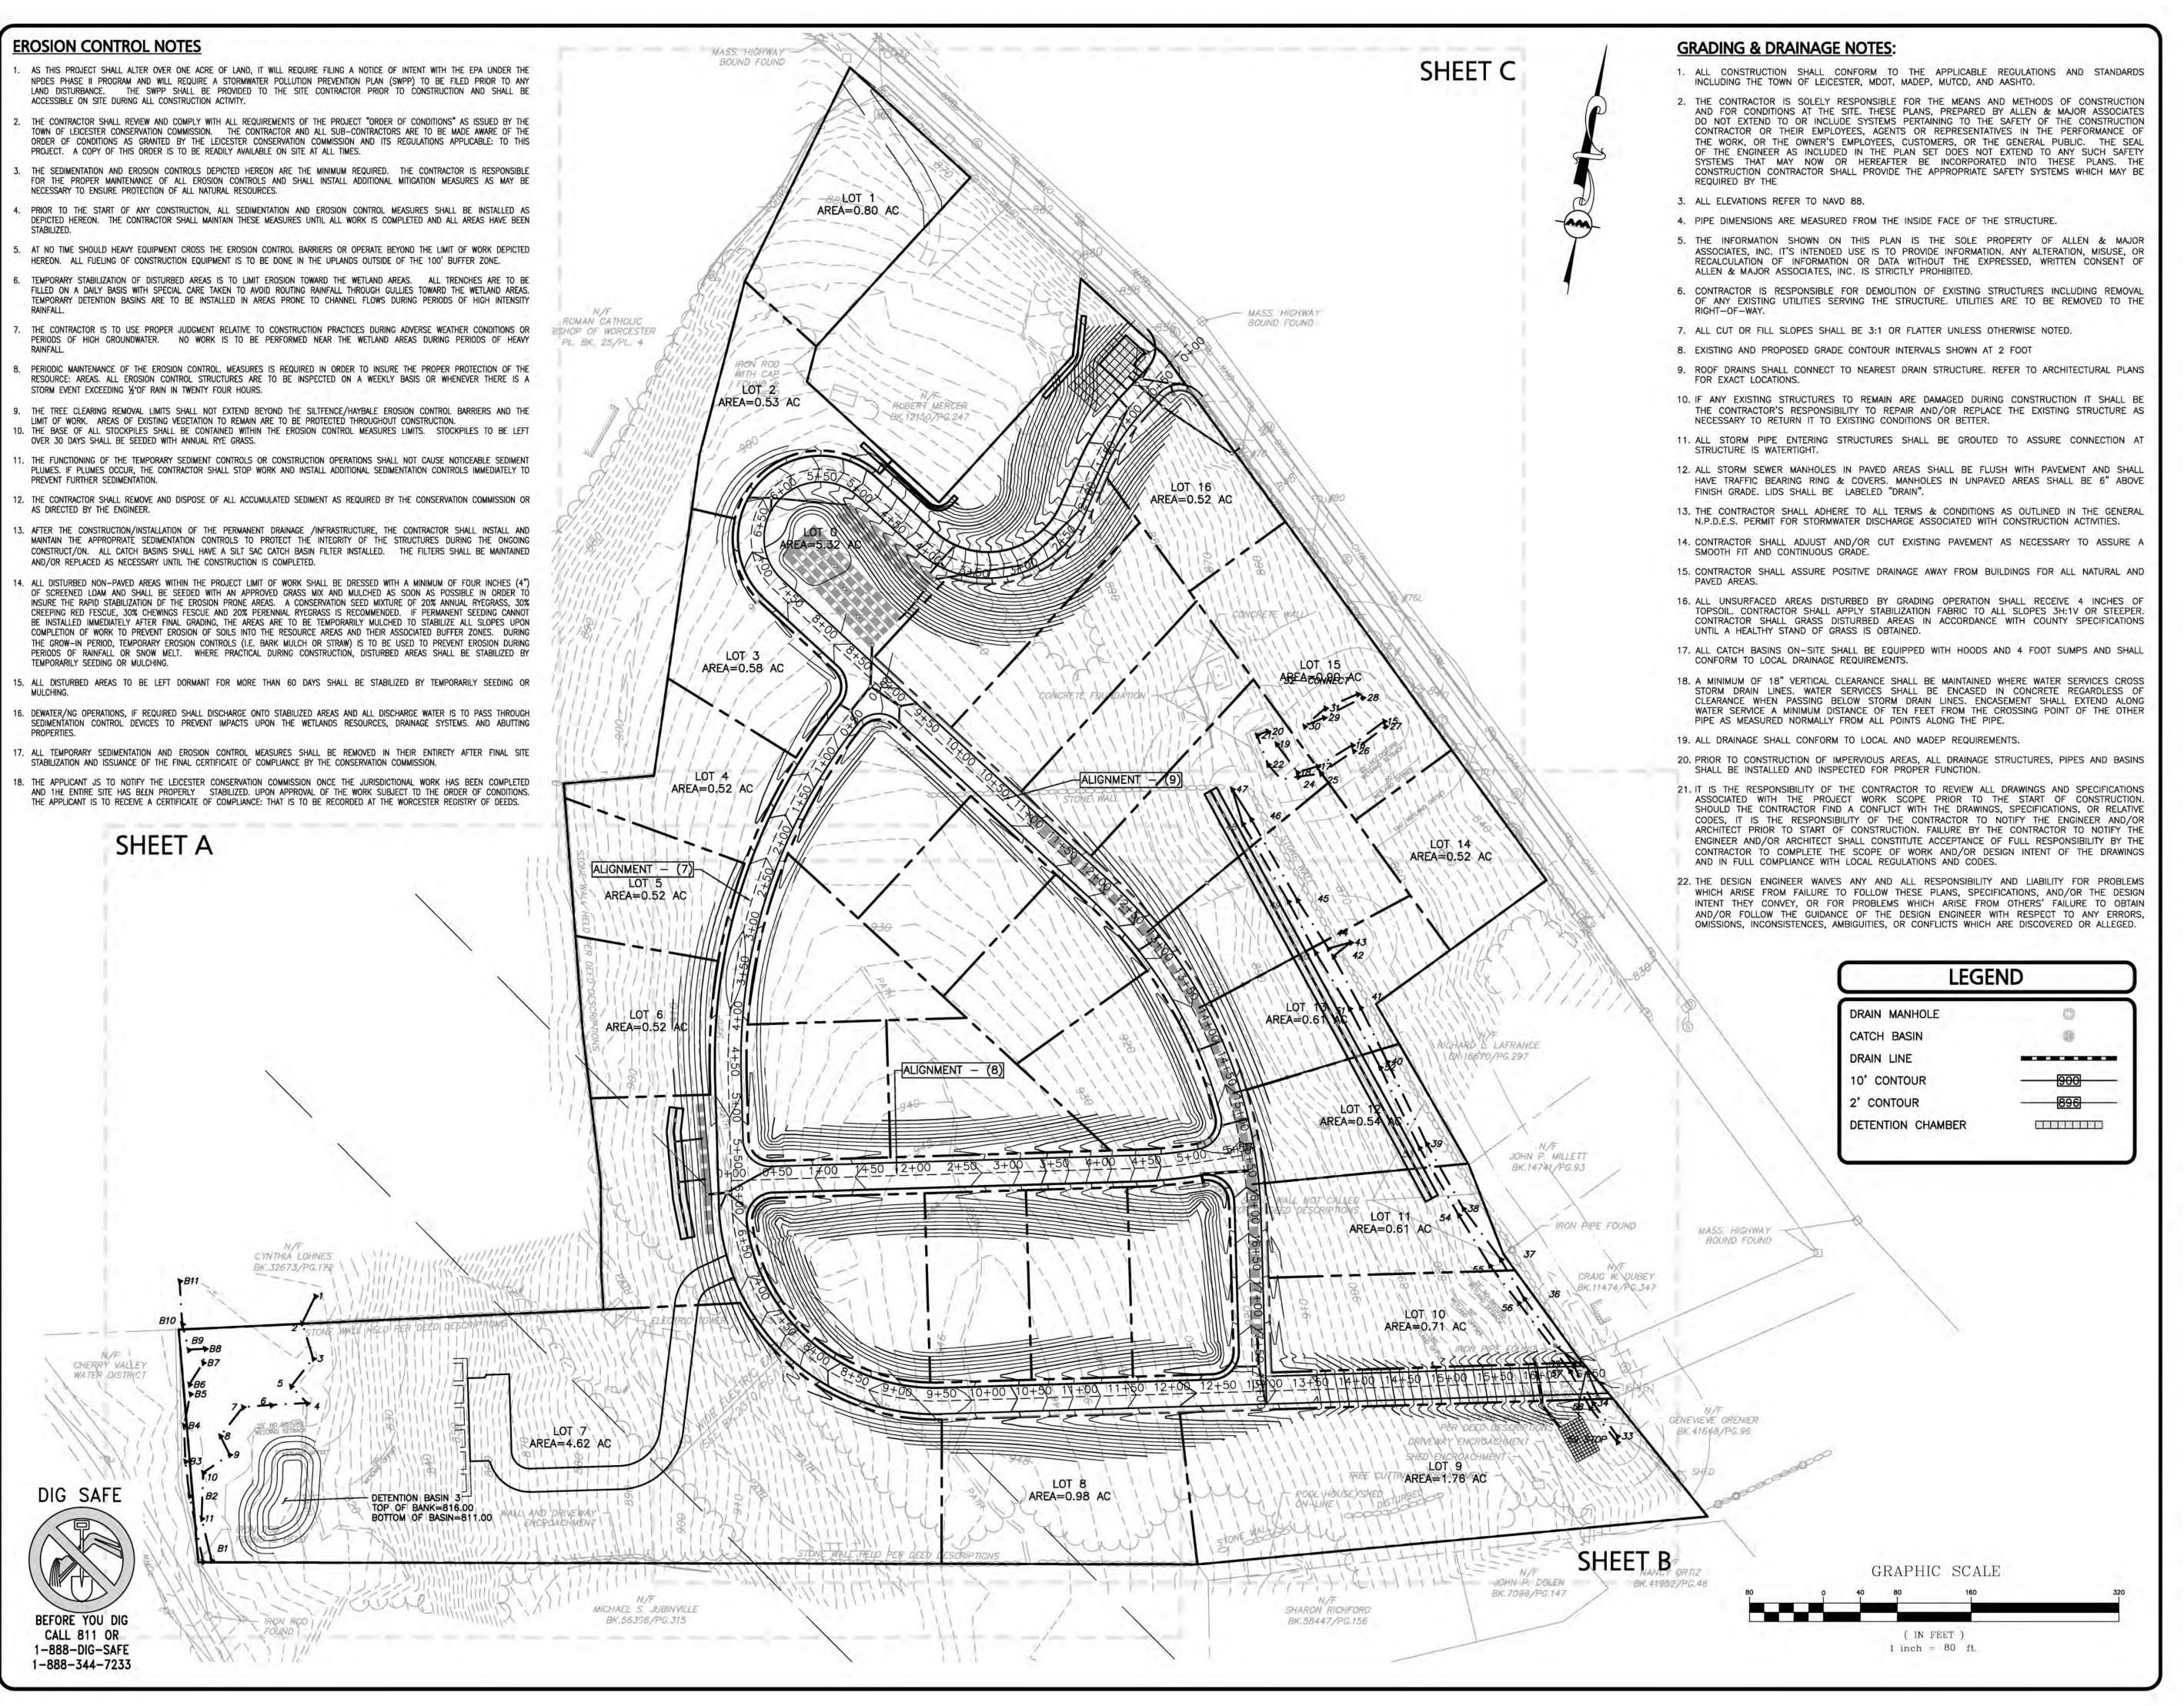
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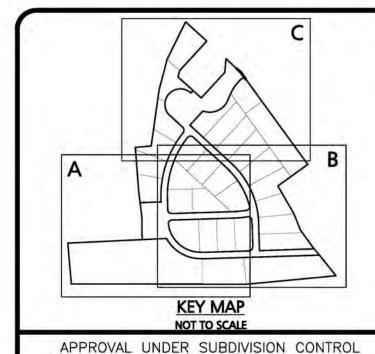
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LEICESTER PLANNING BOARD

I CERTIFY THAT NO NOTICE OF APPEAL WAS RECEIVED DURING THE TWENTY (20) RECORDING DAYS NEXT AFTER RECEIPT AND OF NOTICE FROM THE PLANNING BOARD OF THE APPROVAL OF THIS PLAN

TOWN CLERK - TOWN OF LEICESTER

#### **ISSUED FOR PLANNING BOARD REVIEW JULY 16, 2021**

PROFESSIONAL ENGINEER FOR ALLEN & MAJOR ASSOCIATES, INC.

	11		
REV APPLICAN	DATE	DESCRIPTION	

MKEP 770 LLC 265 SUNRISE HIGHWAY, SUITE 1368 **ROCKVILLE CENTER, NY 11570** 

PROJECT:

**SKYVIEW ESTATES** RESIDENTIAL SUBDIVISION MAIN STREET LEICESTER, MA

2889-01 DATE: PROJECT NO. 07-16-21 SCALE: 1" = 80' DWG. : C-2889-01\_Grading & Drainag

DESIGNED BY: SM CHECKED BY:



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WOBURN, MA . LAKEVILLE, MA . MANCHESTER, NI


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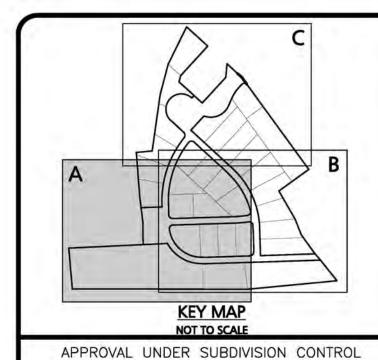
DRAWING TITLE:

SHEET No. **OVERALL GRADING &** C-102 DRAINAGE PLAN

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7 OF 19



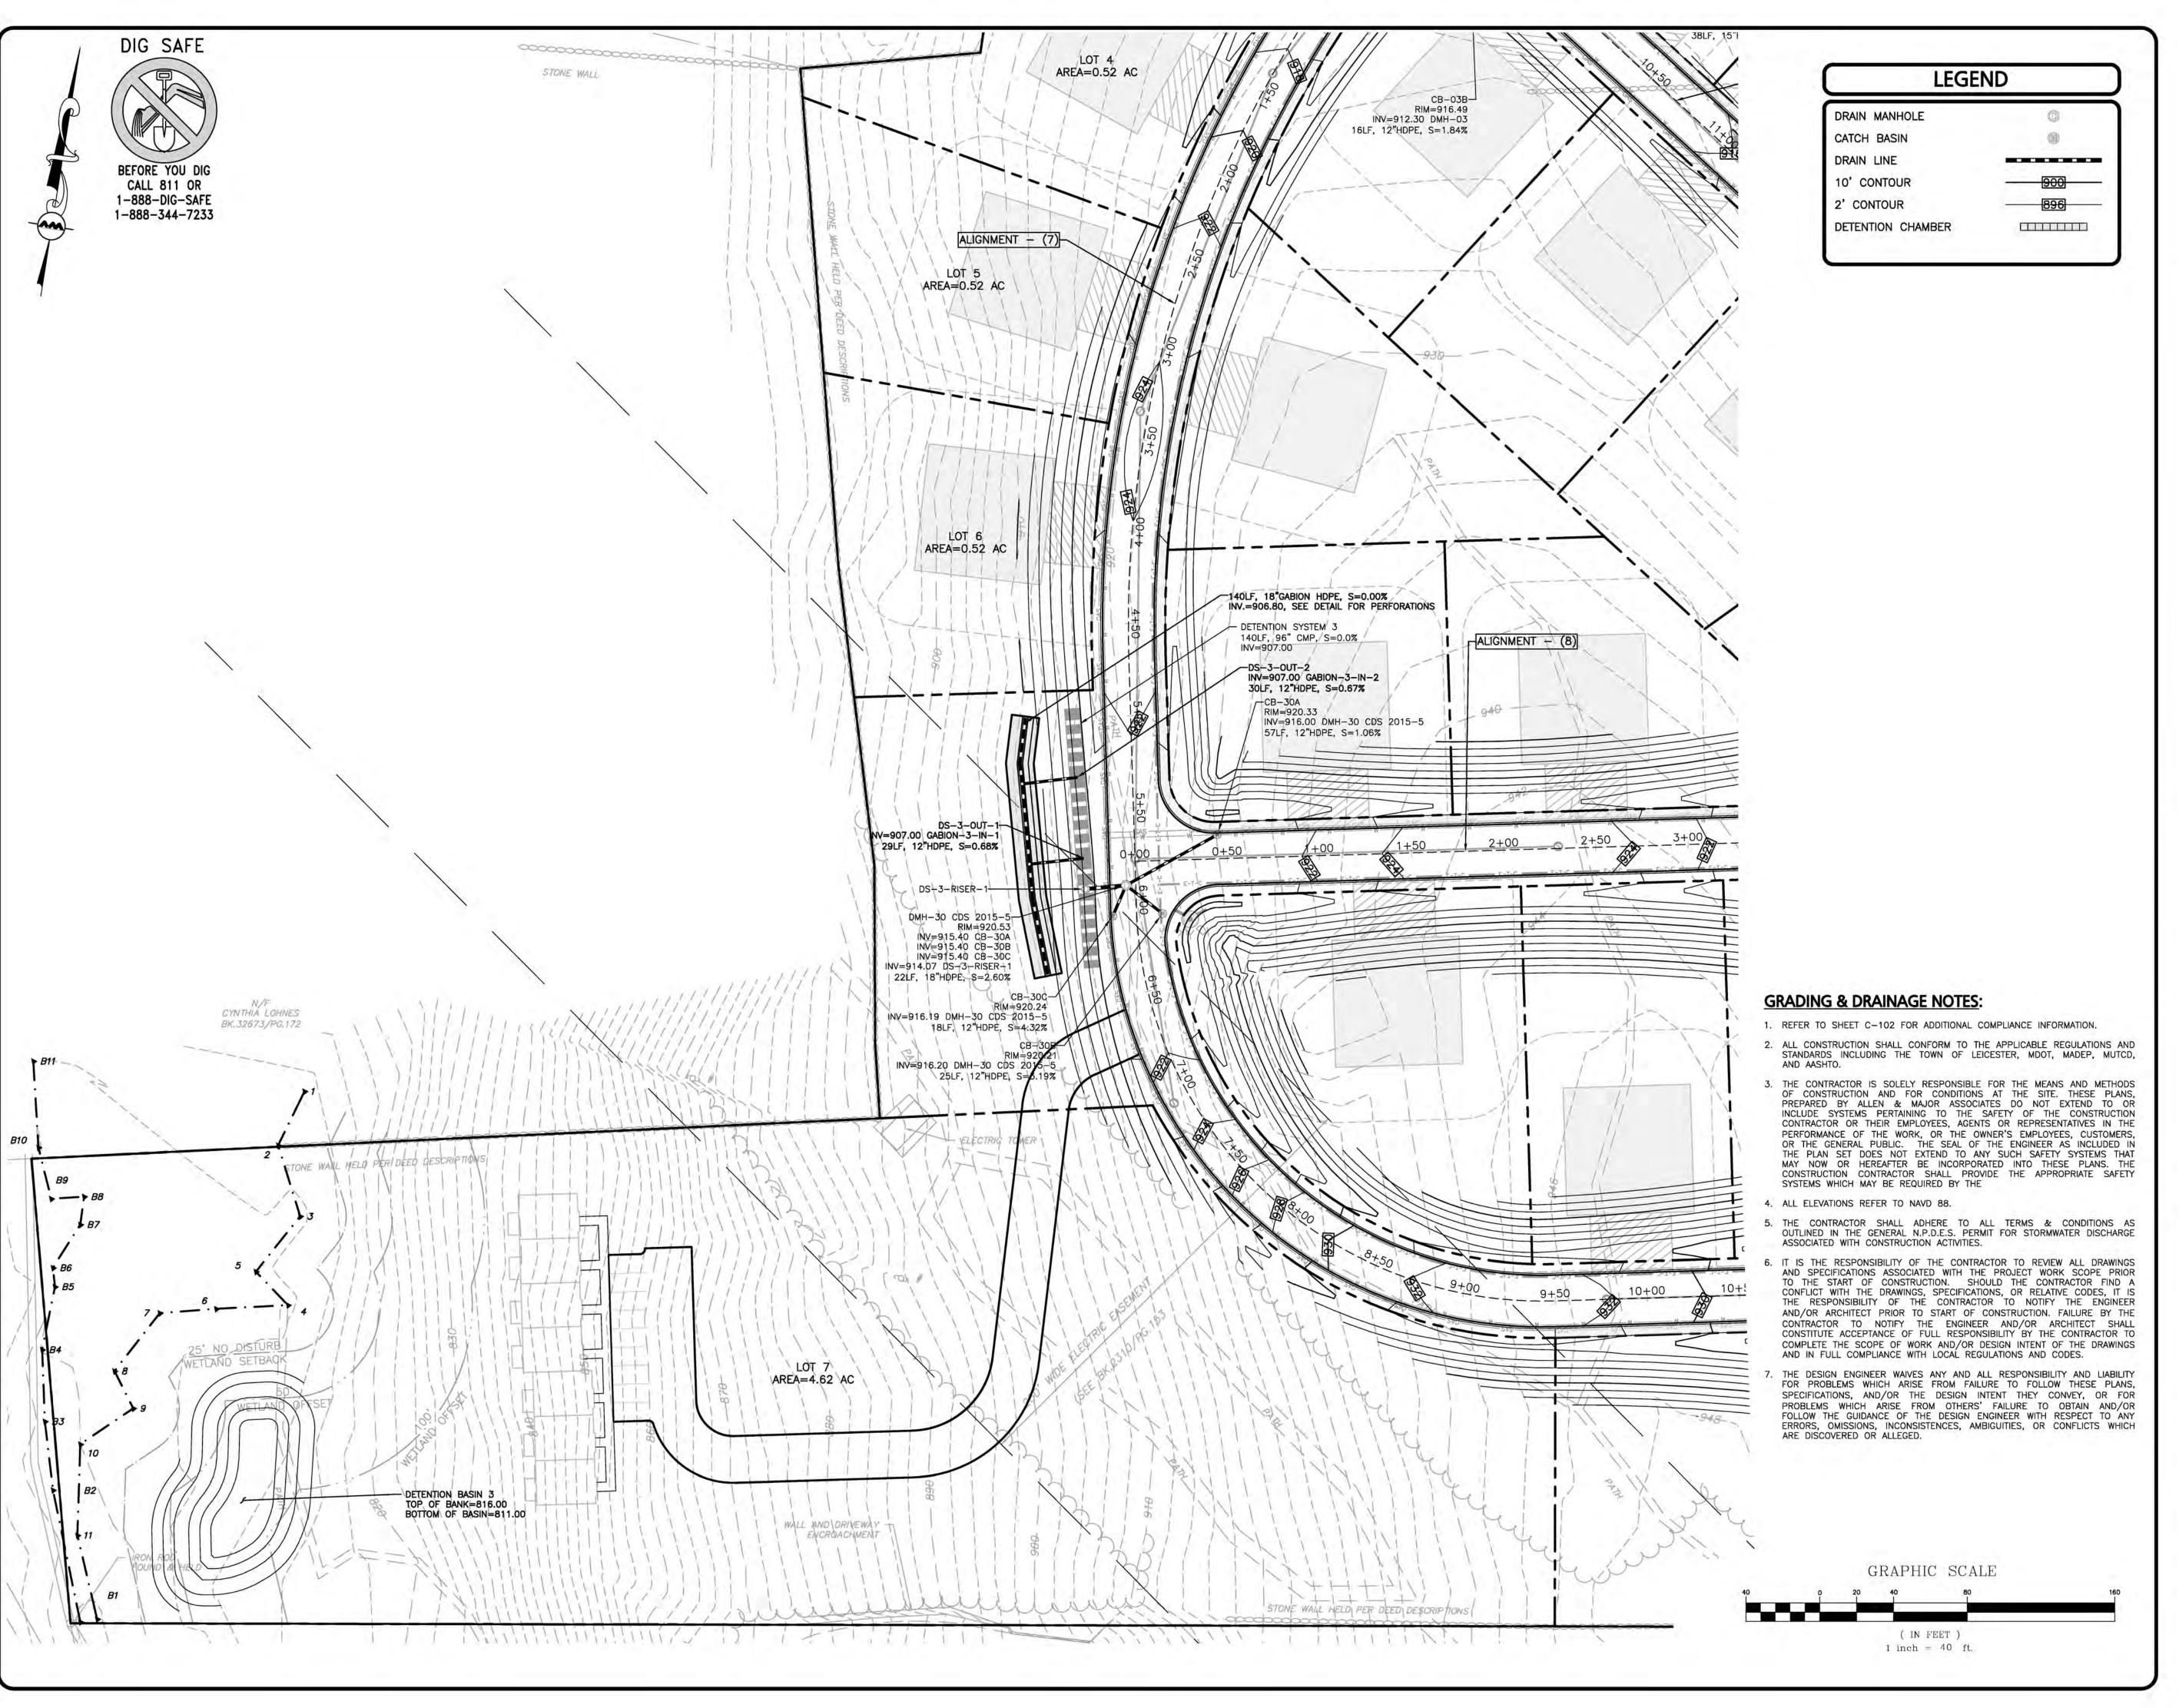

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#### LEICESTER PLANNING BOARD

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TOWN CLERK - TOWN OF LEICESTER

#### **ISSUED FOR PLANNING BOARD REVIEW JULY 16, 2021**

PROFESSIONAL ENGINEER FOR ALLEN & MAJOR ASSOCIATES, INC.

REV	DATE	DESCRIPTION	

#### APPLICANT:

MKEP 770 LLC 265 SUNRISE HIGHWAY, SUITE 1368 **ROCKVILLE CENTER, NY 11570** 

#### PROJECT:

**SKYVIEW ESTATES RESIDENTIAL SUBDIVISION MAIN STREET** LEICESTER, MA

2889-01 DATE: 07-16-21 PROJECT NO. SCALE: 1" = ##' DWG. : c-2889-01\_grading & drainage

**DESIGNED BY:** SM CHECKED BY:



#### ASSOCIATES, INC. civil engineering . land surveying

environmental consulting . landscape architecture www.allenmajor.com 100 COMMERCE WAY, SUITE 5 WOBURN MA 01801 TEL: (781) 935-6889

WOBURN, MA . LAKEVILLE, MA . MANCHESTER, NH

FAX: (781) 935-2896


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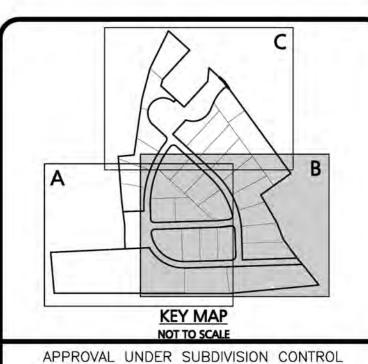
DRAWING TITLE: **GRADING & DRAINAGE** 

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SHEET No.

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#### LEICESTER PLANNING BOARD

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TOWN CLERK - TOWN OF LEICESTER

#### **ISSUED FOR PLANNING BOARD REVIEW JULY 16, 2021**

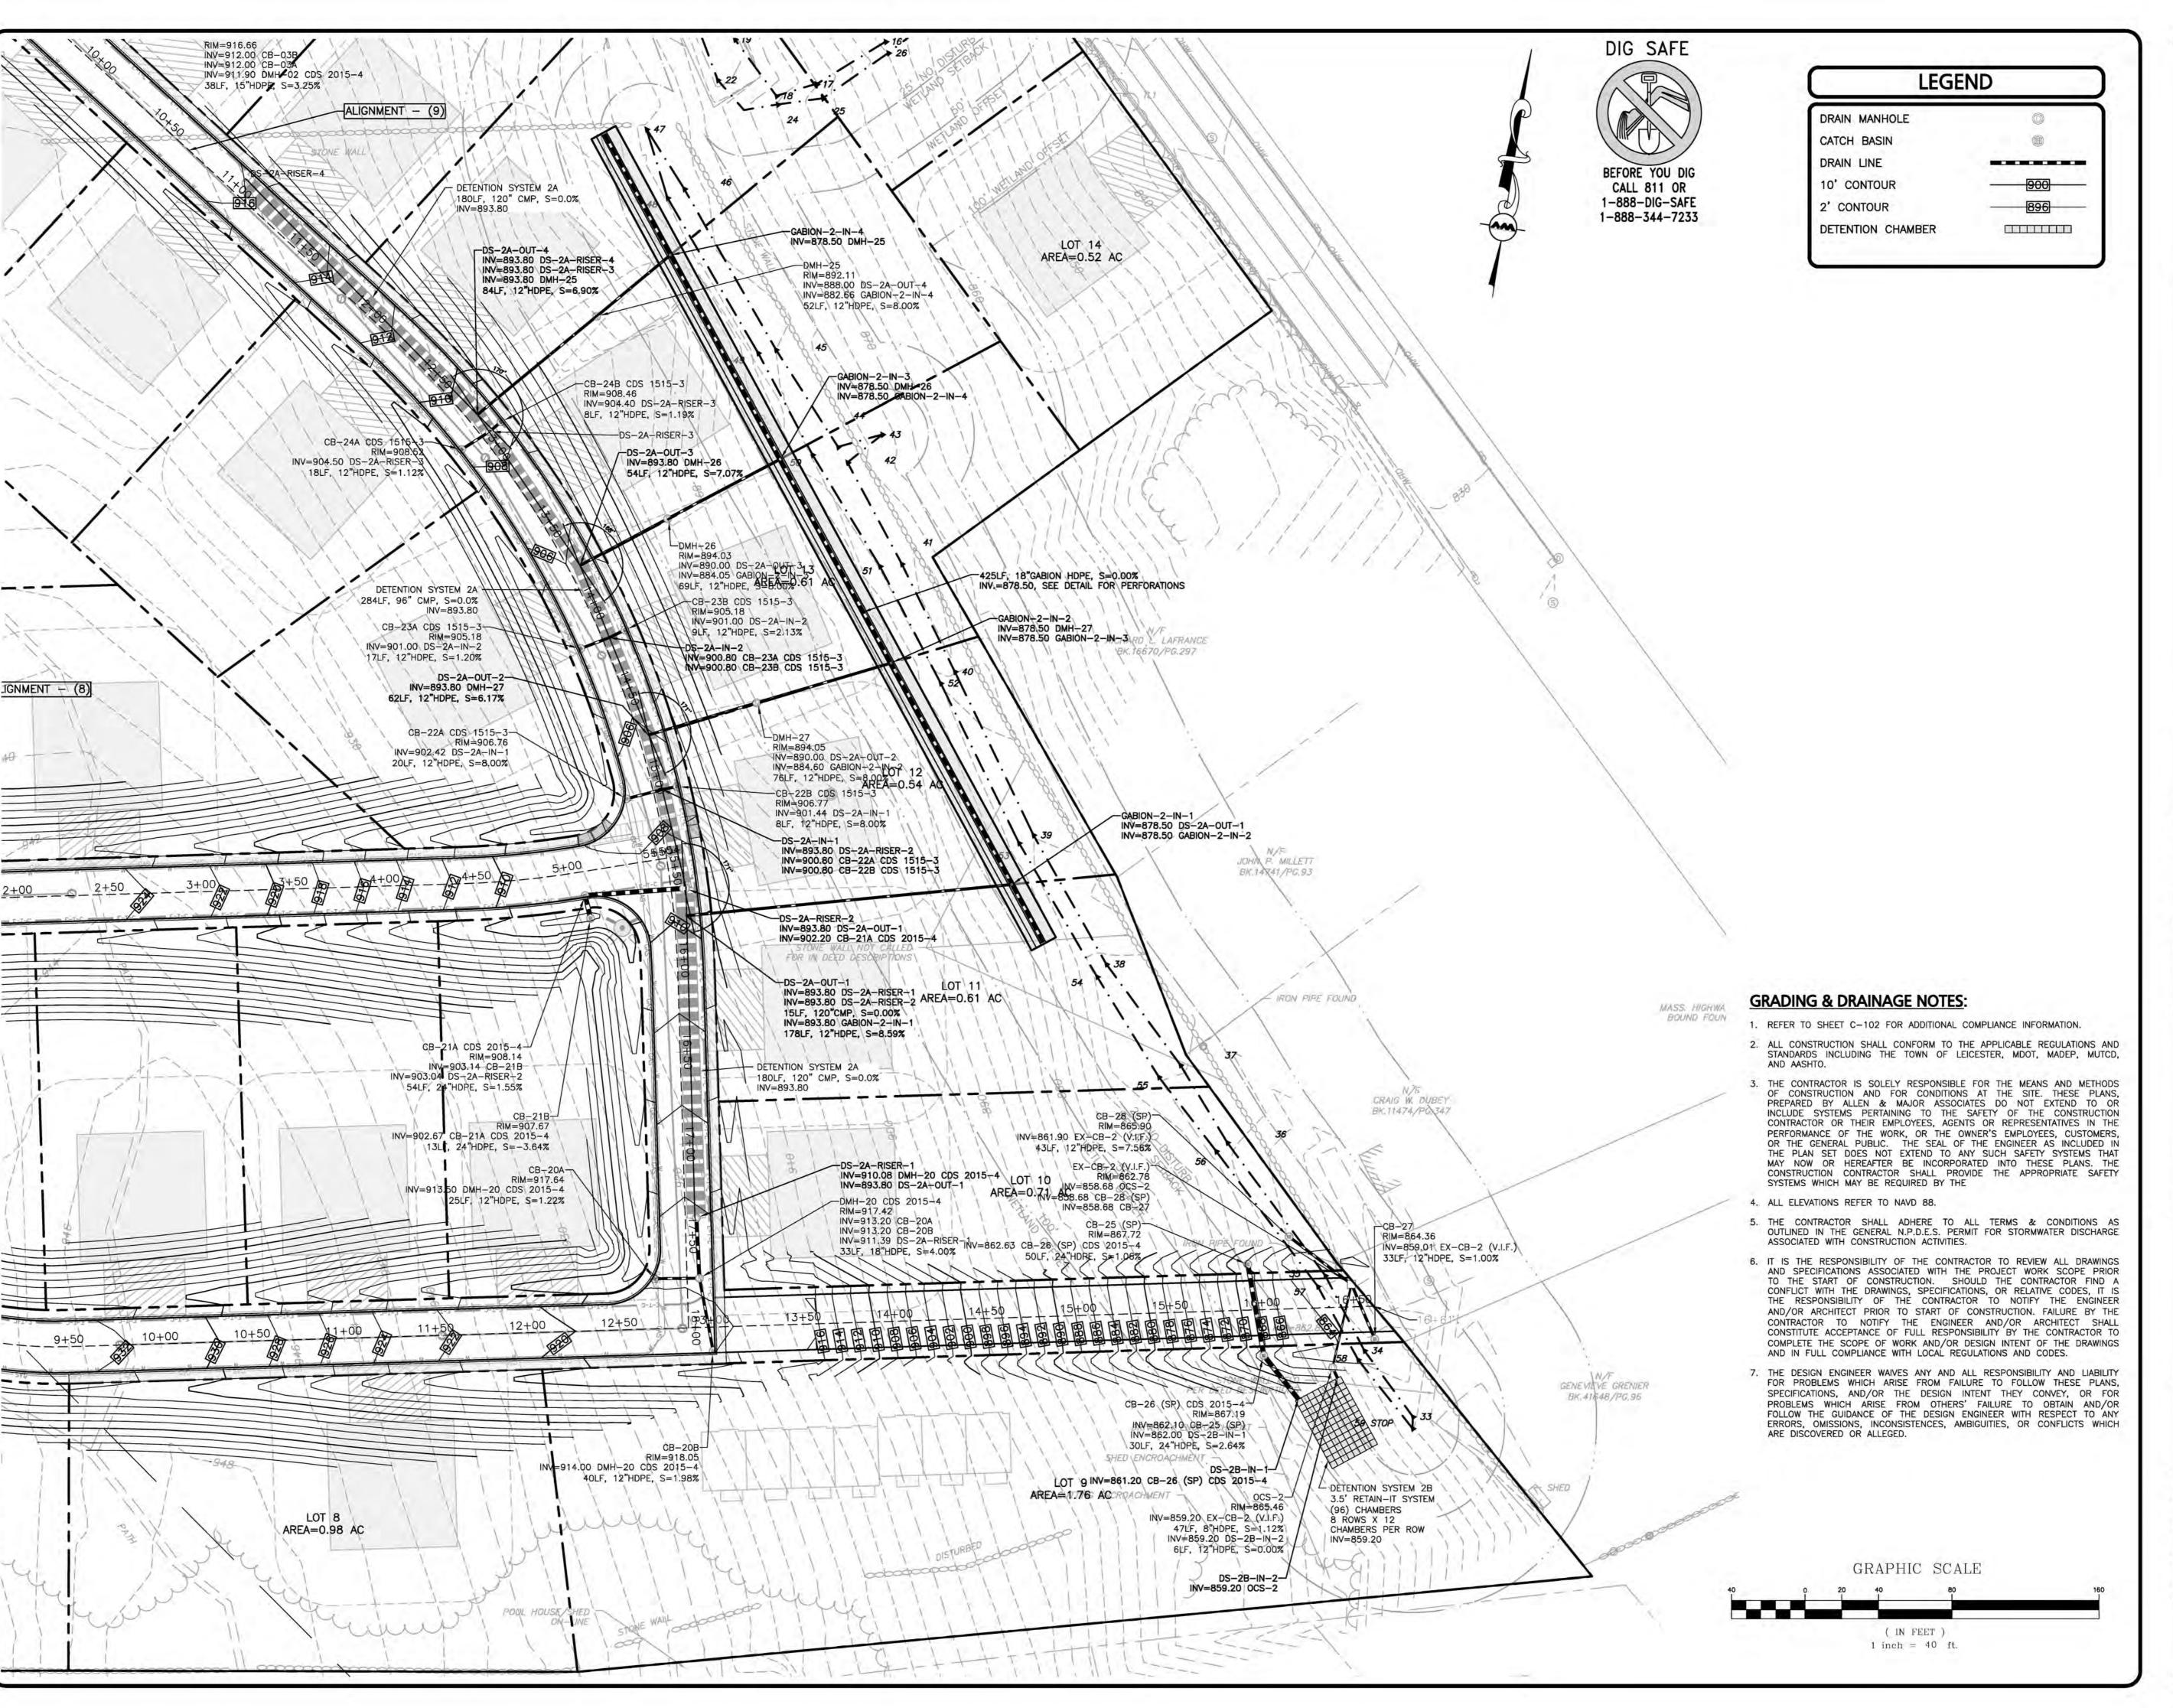PROFESSIONAL ENGINEER FOR ALLEN & MAJOR ASSOCIATES, INC.

	REV	DATE	DESCRIPTION	
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#### APPLICANT:

MKEP 770 LLC 265 SUNRISE HIGHWAY, SUITE 1368 **ROCKVILLE CENTER, NY 11570** 

PROJECT:

**SKYVIEW ESTATES RESIDENTIAL SUBDIVISION** MAIN STREET LEICESTER, MA

2889-01 DATE: 07-16-21 PROJECT NO. SCALE: 1" = ##' DWG. : c-2889-01\_grading & drainag

**DESIGNED BY:** SM CHECKED BY:



ASSOCIATES, INC. civil engineering . land surveying nvironmental consulting • landscape architectur

www.allenmajor.com 100 COMMERCE WAY, SUITE 5 WOBURN MA 01801 TEL: (781) 935-6889 FAX: (781) 935-2896

#### WOBURN, MA . LAKEVILLE, MA . MANCHESTER, NH HIS DRAWING HAS BEEN PREPARED IN DIGITAL FORMA

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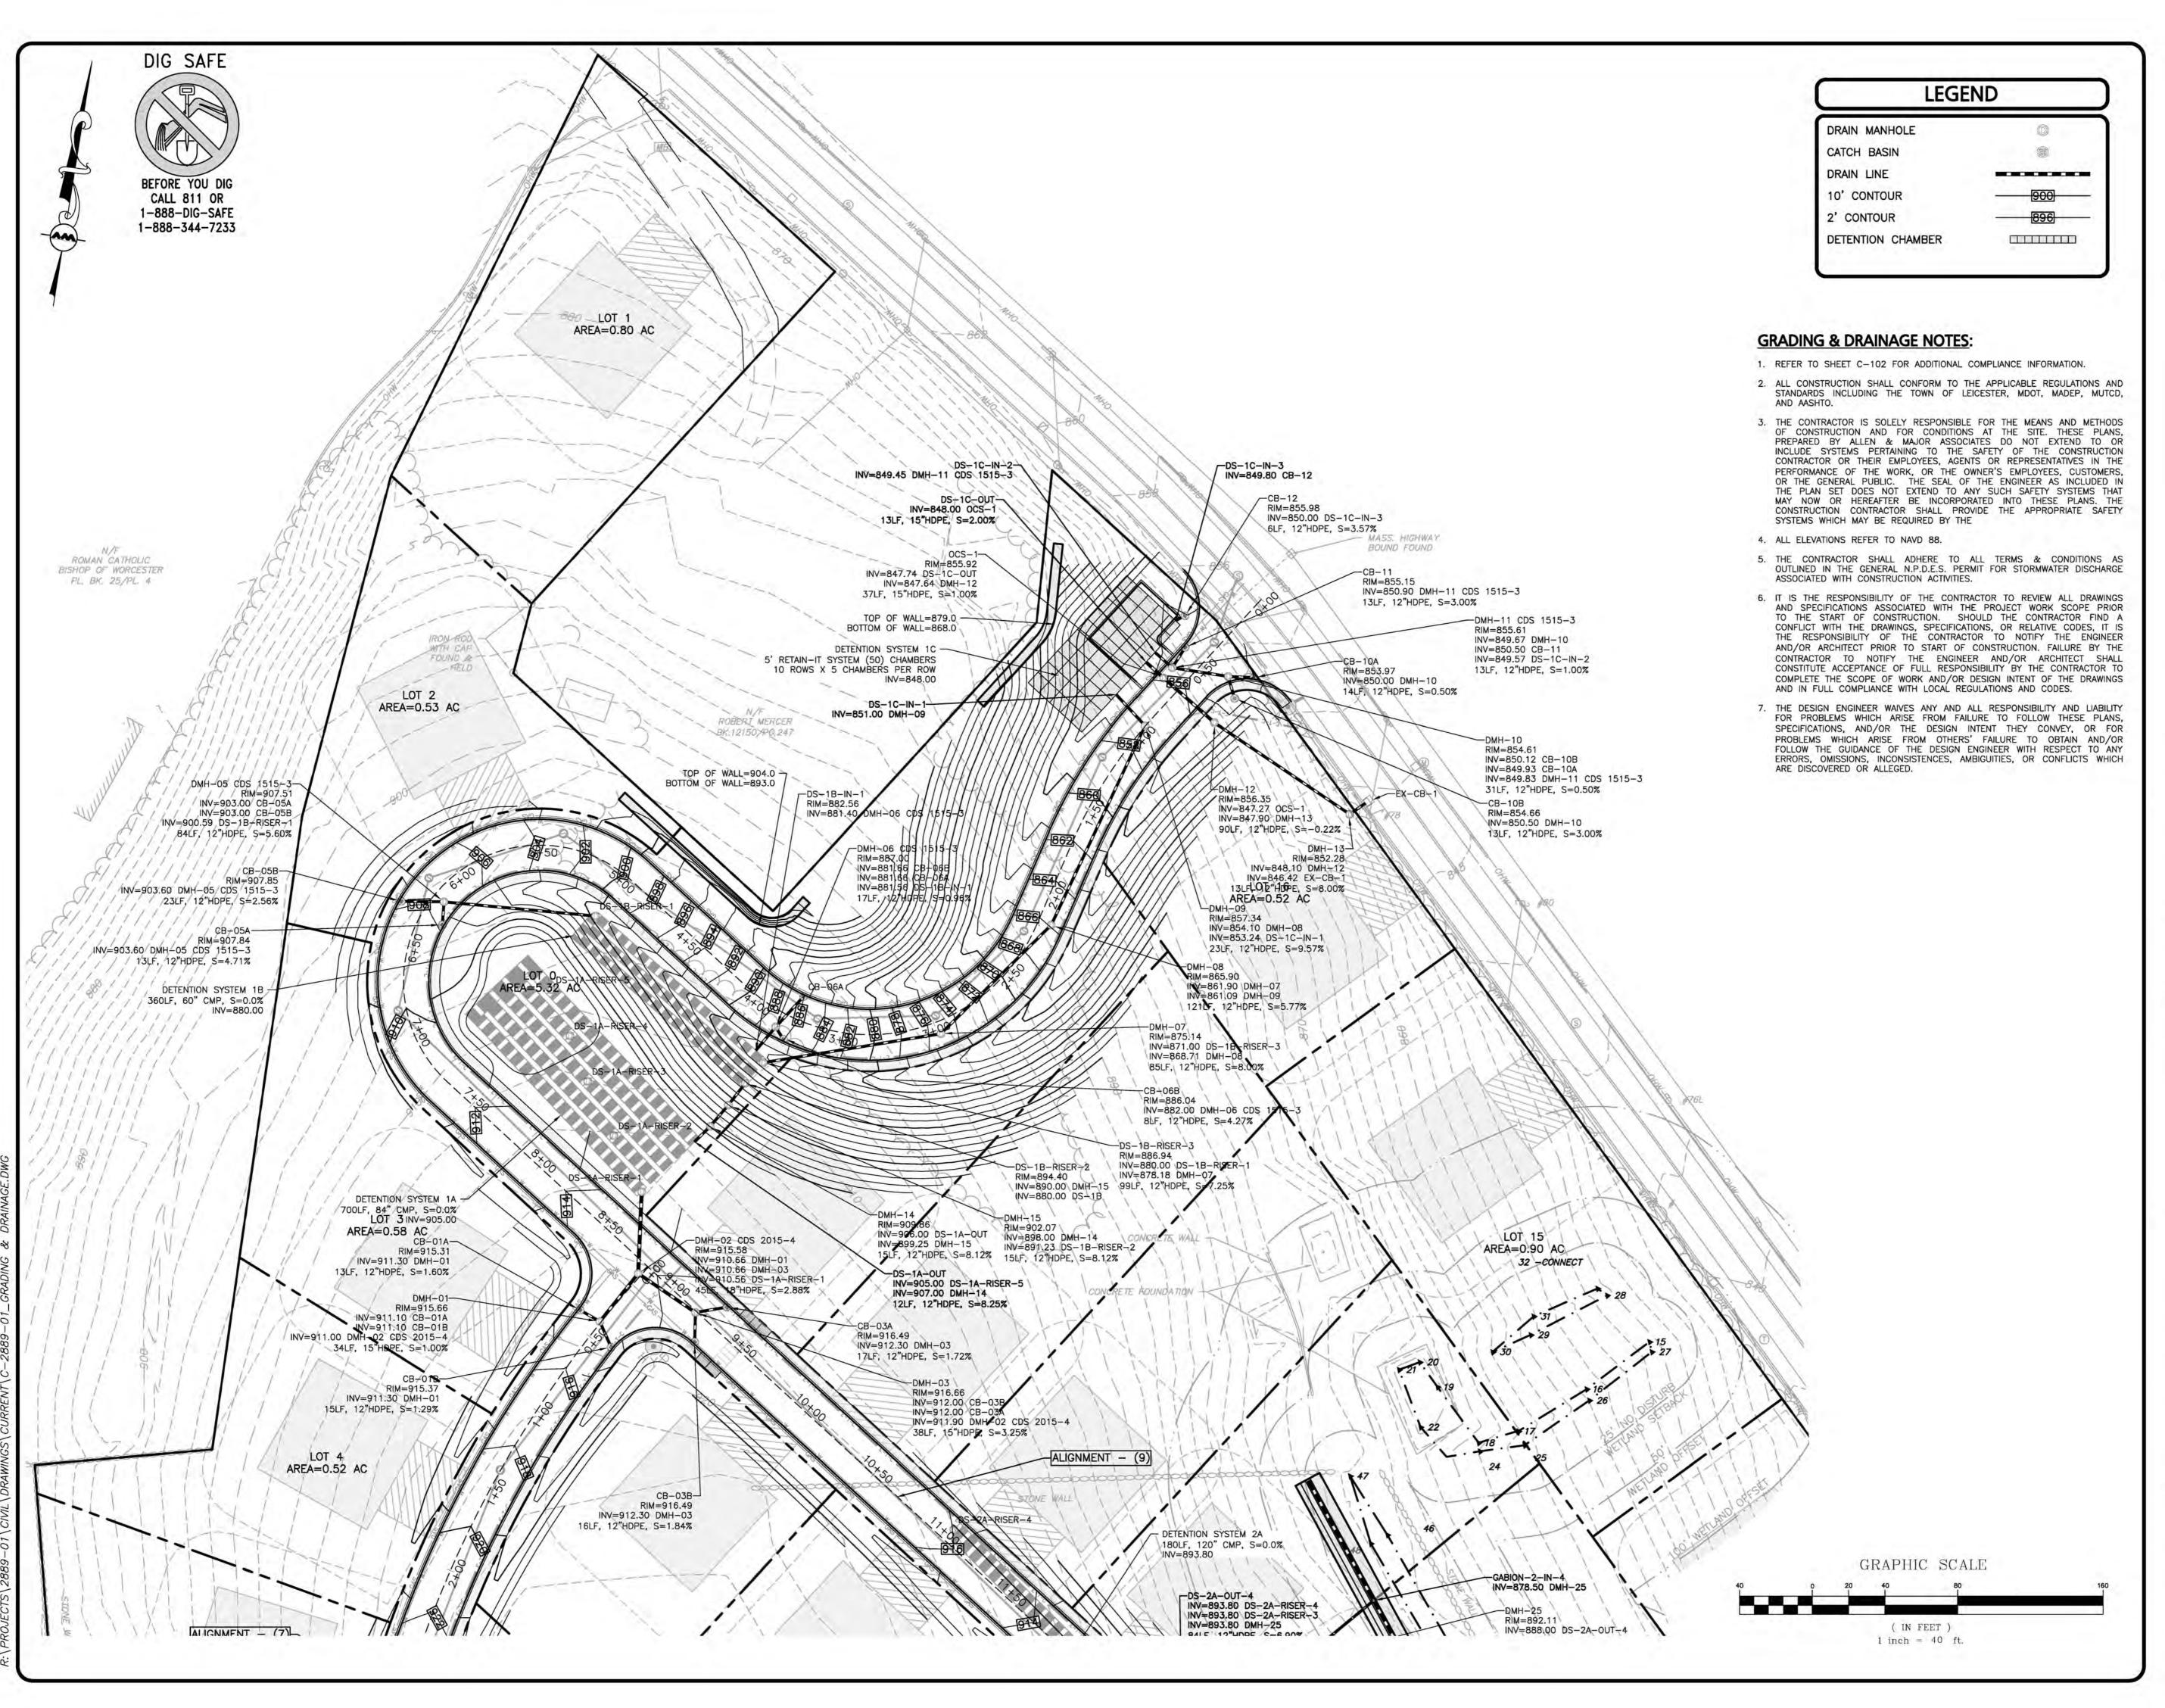
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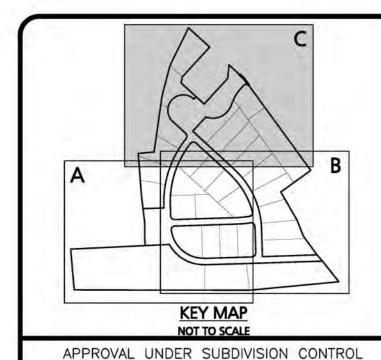
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TOWN CLERK - TOWN OF LEICESTER

AND OF NOTICE FROM THE PLANNING

BOARD OF THE APPROVAL OF THIS PLAN

# ISSUED FOR PLANNING BOARD REVIEW JULY 16, 2021

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REV	DATE	DESCRIPTION

MKEP 770 LLC 265 SUNRISE HIGHWAY, SUITE 1368 ROCKVILLE CENTER, NY 11570

PROJECT

PROJECT NO.

SKYVIEW ESTATES
RESIDENTIAL SUBDIVISION
MAIN STREET
LEICESTER, MA

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SCALE:	1" = ##'	DWG. : c-2889-01_gra	ding & drain
DESIGNED BY:	SM	CHECKED BY:	MA
PREPARED BY:			

2889-01 DATE:

07-16-21



civil engineering ◆ land surveying
nvironmental consulting ◆ landscape architectur
w w w . a l l e n m a j o r . c o m
100 COMMERCE WAY, SUITE 5
WOBURN MA 01801
TEL: (781) 935-6889

#### WOBURN, MA ◆ LAKEVILLE, MA ◆ MANCHESTER, NH

FAX: (781) 935-2896

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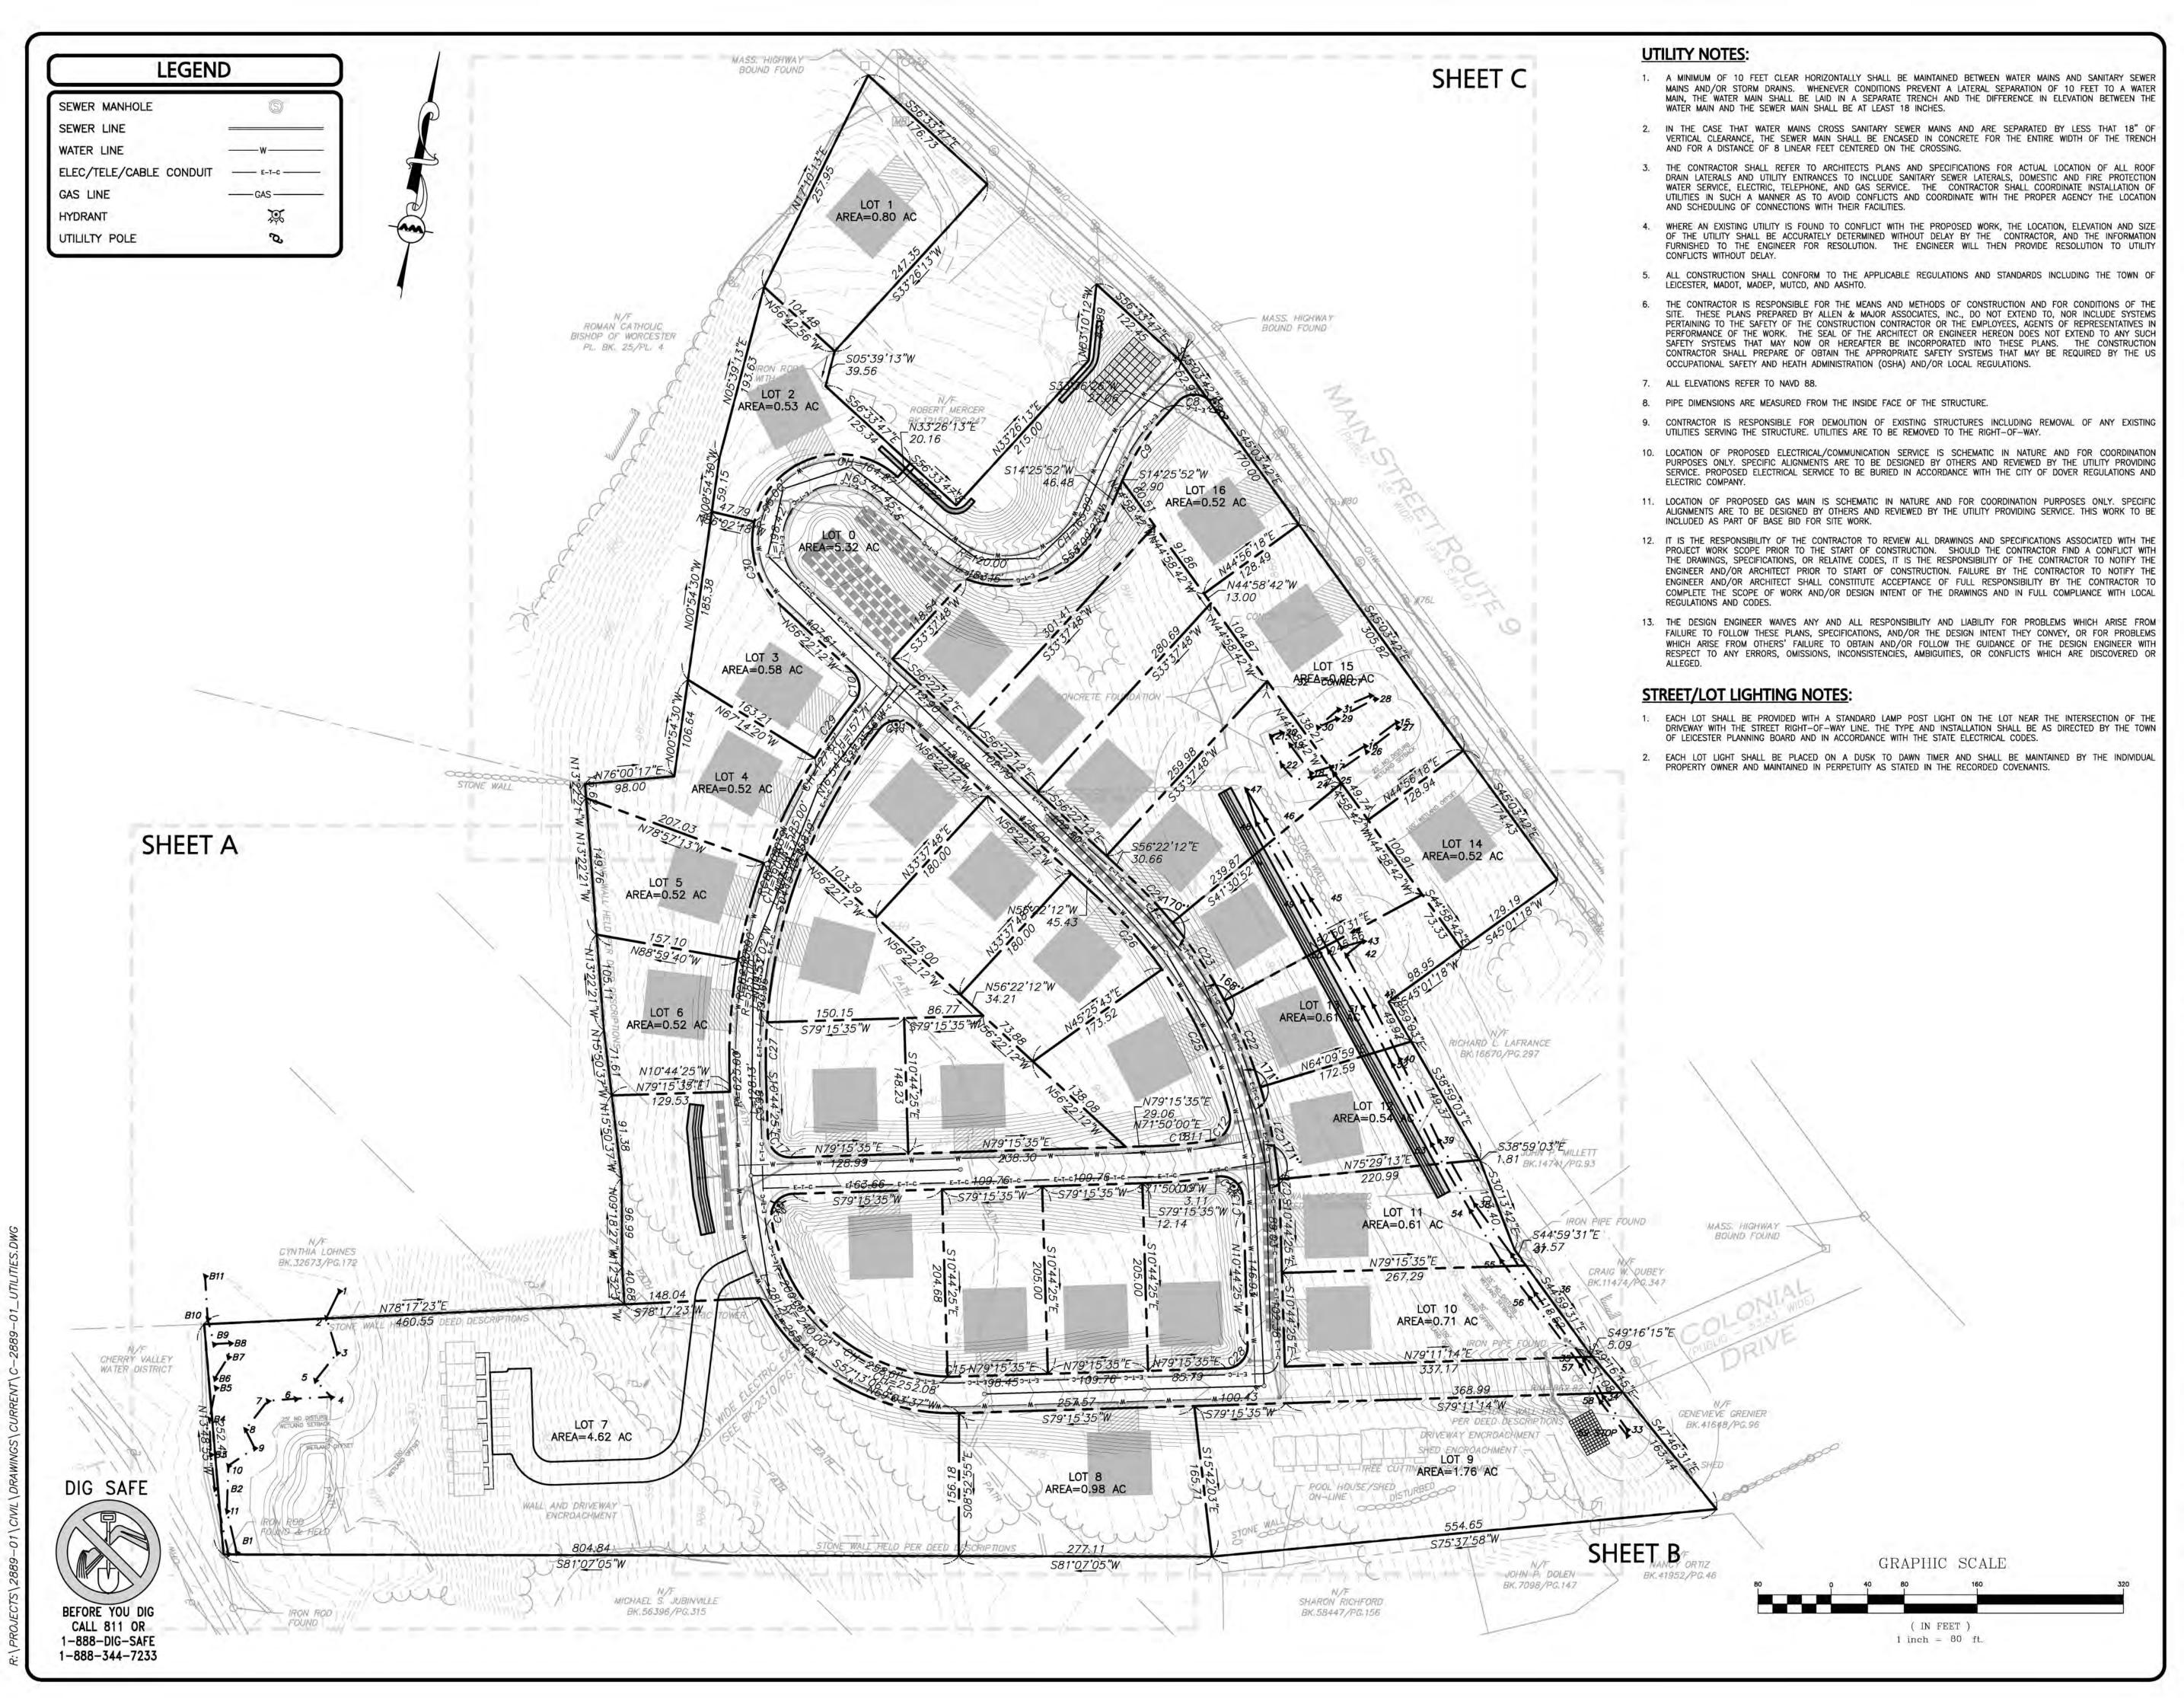
GRADING & DRAINAGE PLAN


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	LEICESTER	PLANNI	NG BOARD	

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TOWN CLERK - TOWN OF LEICESTER

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PROFESSIONAL ENGINEER FOR ALLEN & MAJOR ASSOCIATES, INC.

REV	DATE	DESCRIPTION	

MKEP 770 LLC 265 SUNRISE HIGHWAY, SUITE 1368 **ROCKVILLE CENTER, NY 11570** 

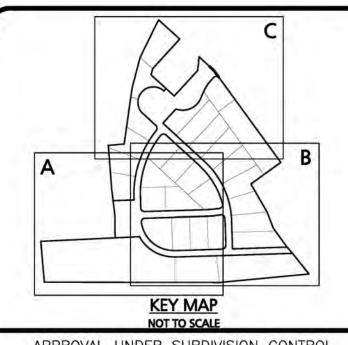PROJECT:

**SKYVIEW ESTATES RESIDENTIAL SUBDIVISION MAIN STREET** LEICESTER, MA

2889-01 DATE: PROJECT NO. 07-16-21 1" = 80' DWG. : C-2889-01\_Utilitie **DESIGNED BY:** SM CHECKED BY:



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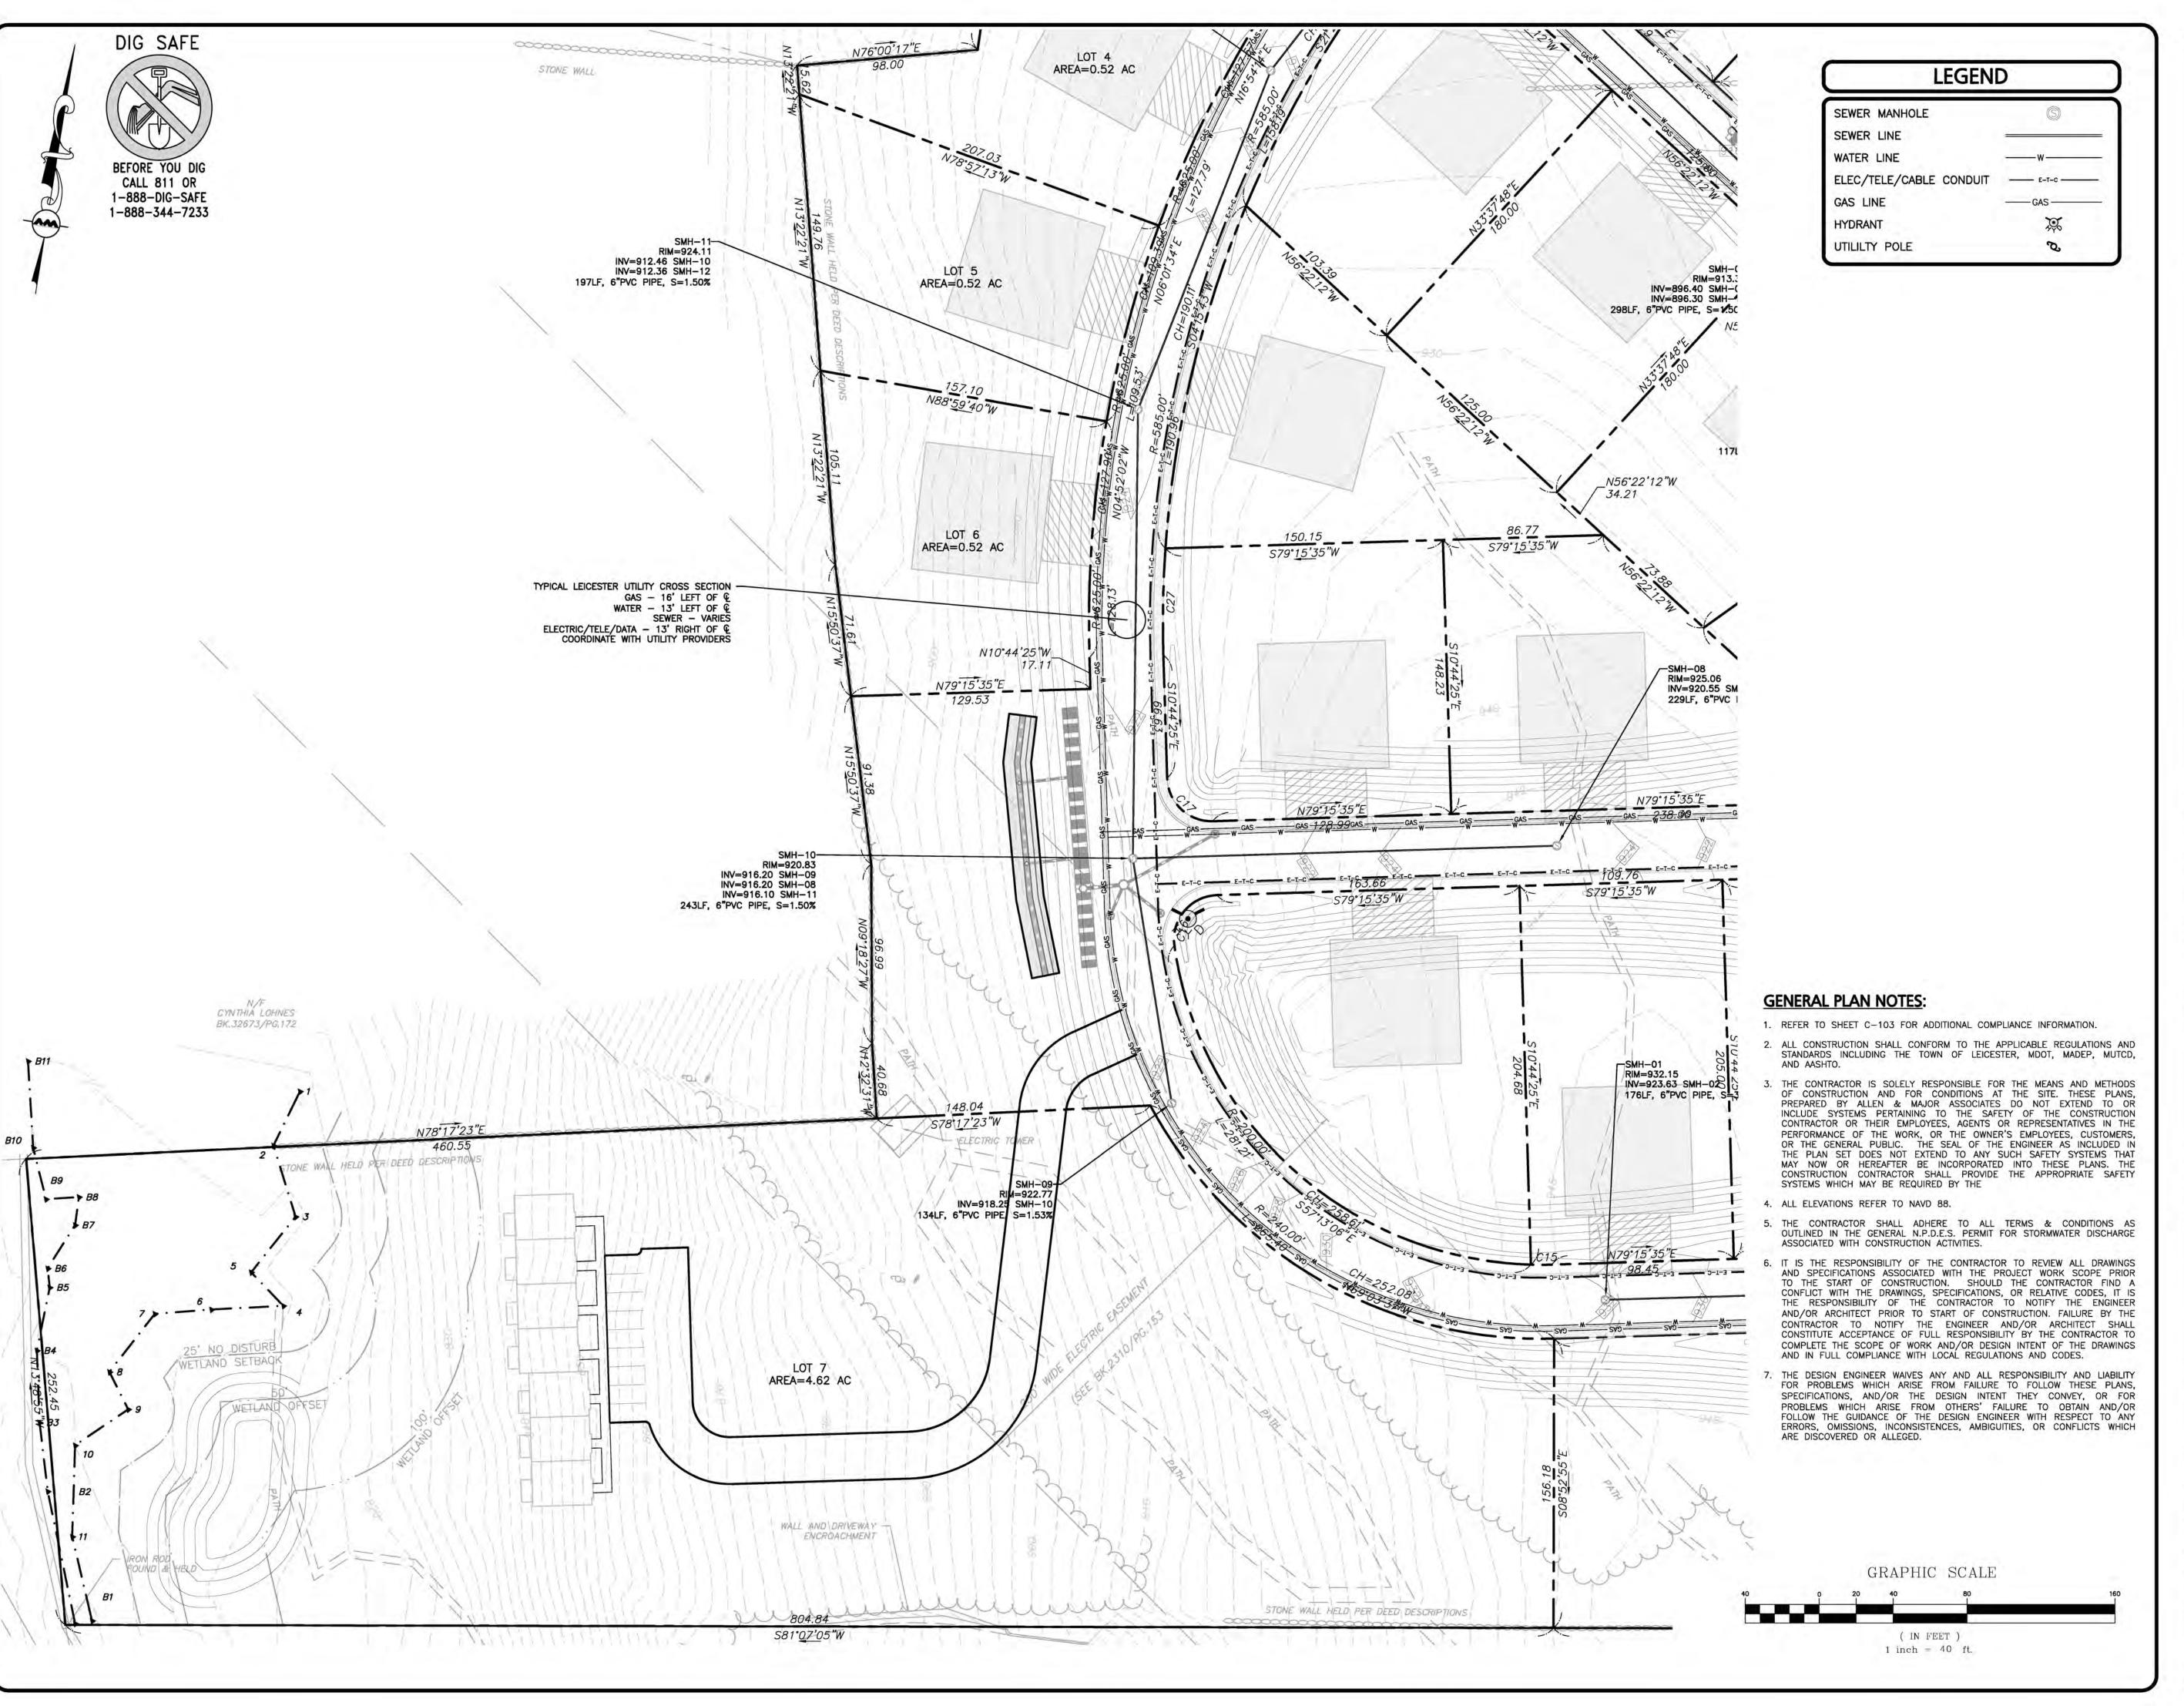
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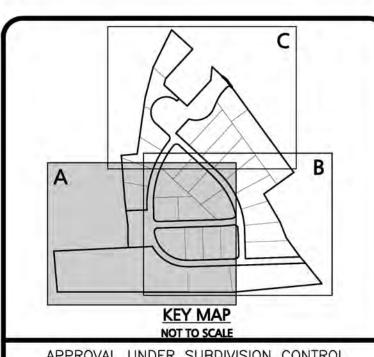
C-103 **OVERALL UTILITIES PLAN** 

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#### **ISSUED FOR PLANNING BOARD REVIEW JULY 16, 2021**

AND OF NOTICE FROM THE PLANNING

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TOWN CLERK - TOWN OF LEICESTER

PROFESSIONAL ENGINEER FOR ALLEN & MAJOR ASSOCIATES, INC.

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MKEP 770 LLC 265 SUNRISE HIGHWAY, SUITE 1368 **ROCKVILLE CENTER, NY 11570** 

PROJECT:

**SKYVIEW ESTATES RESIDENTIAL SUBDIVISION MAIN STREET** LEICESTER, MA

2889-01 DATE: PROJECT NO. 07-16-21 1" = ##' DWG. : C-2889-01\_Utilities SCALE:

DESIGNED BY: SM CHECKED BY:



ASSOCIATES, INC. civil engineering . land surveying environmental consulting . landscape architecture

www.allenmajor.com 100 COMMERCE WAY, SUITE 5 WOBURN MA 01801 TEL: (781) 935-6889 FAX: (781) 935-2896

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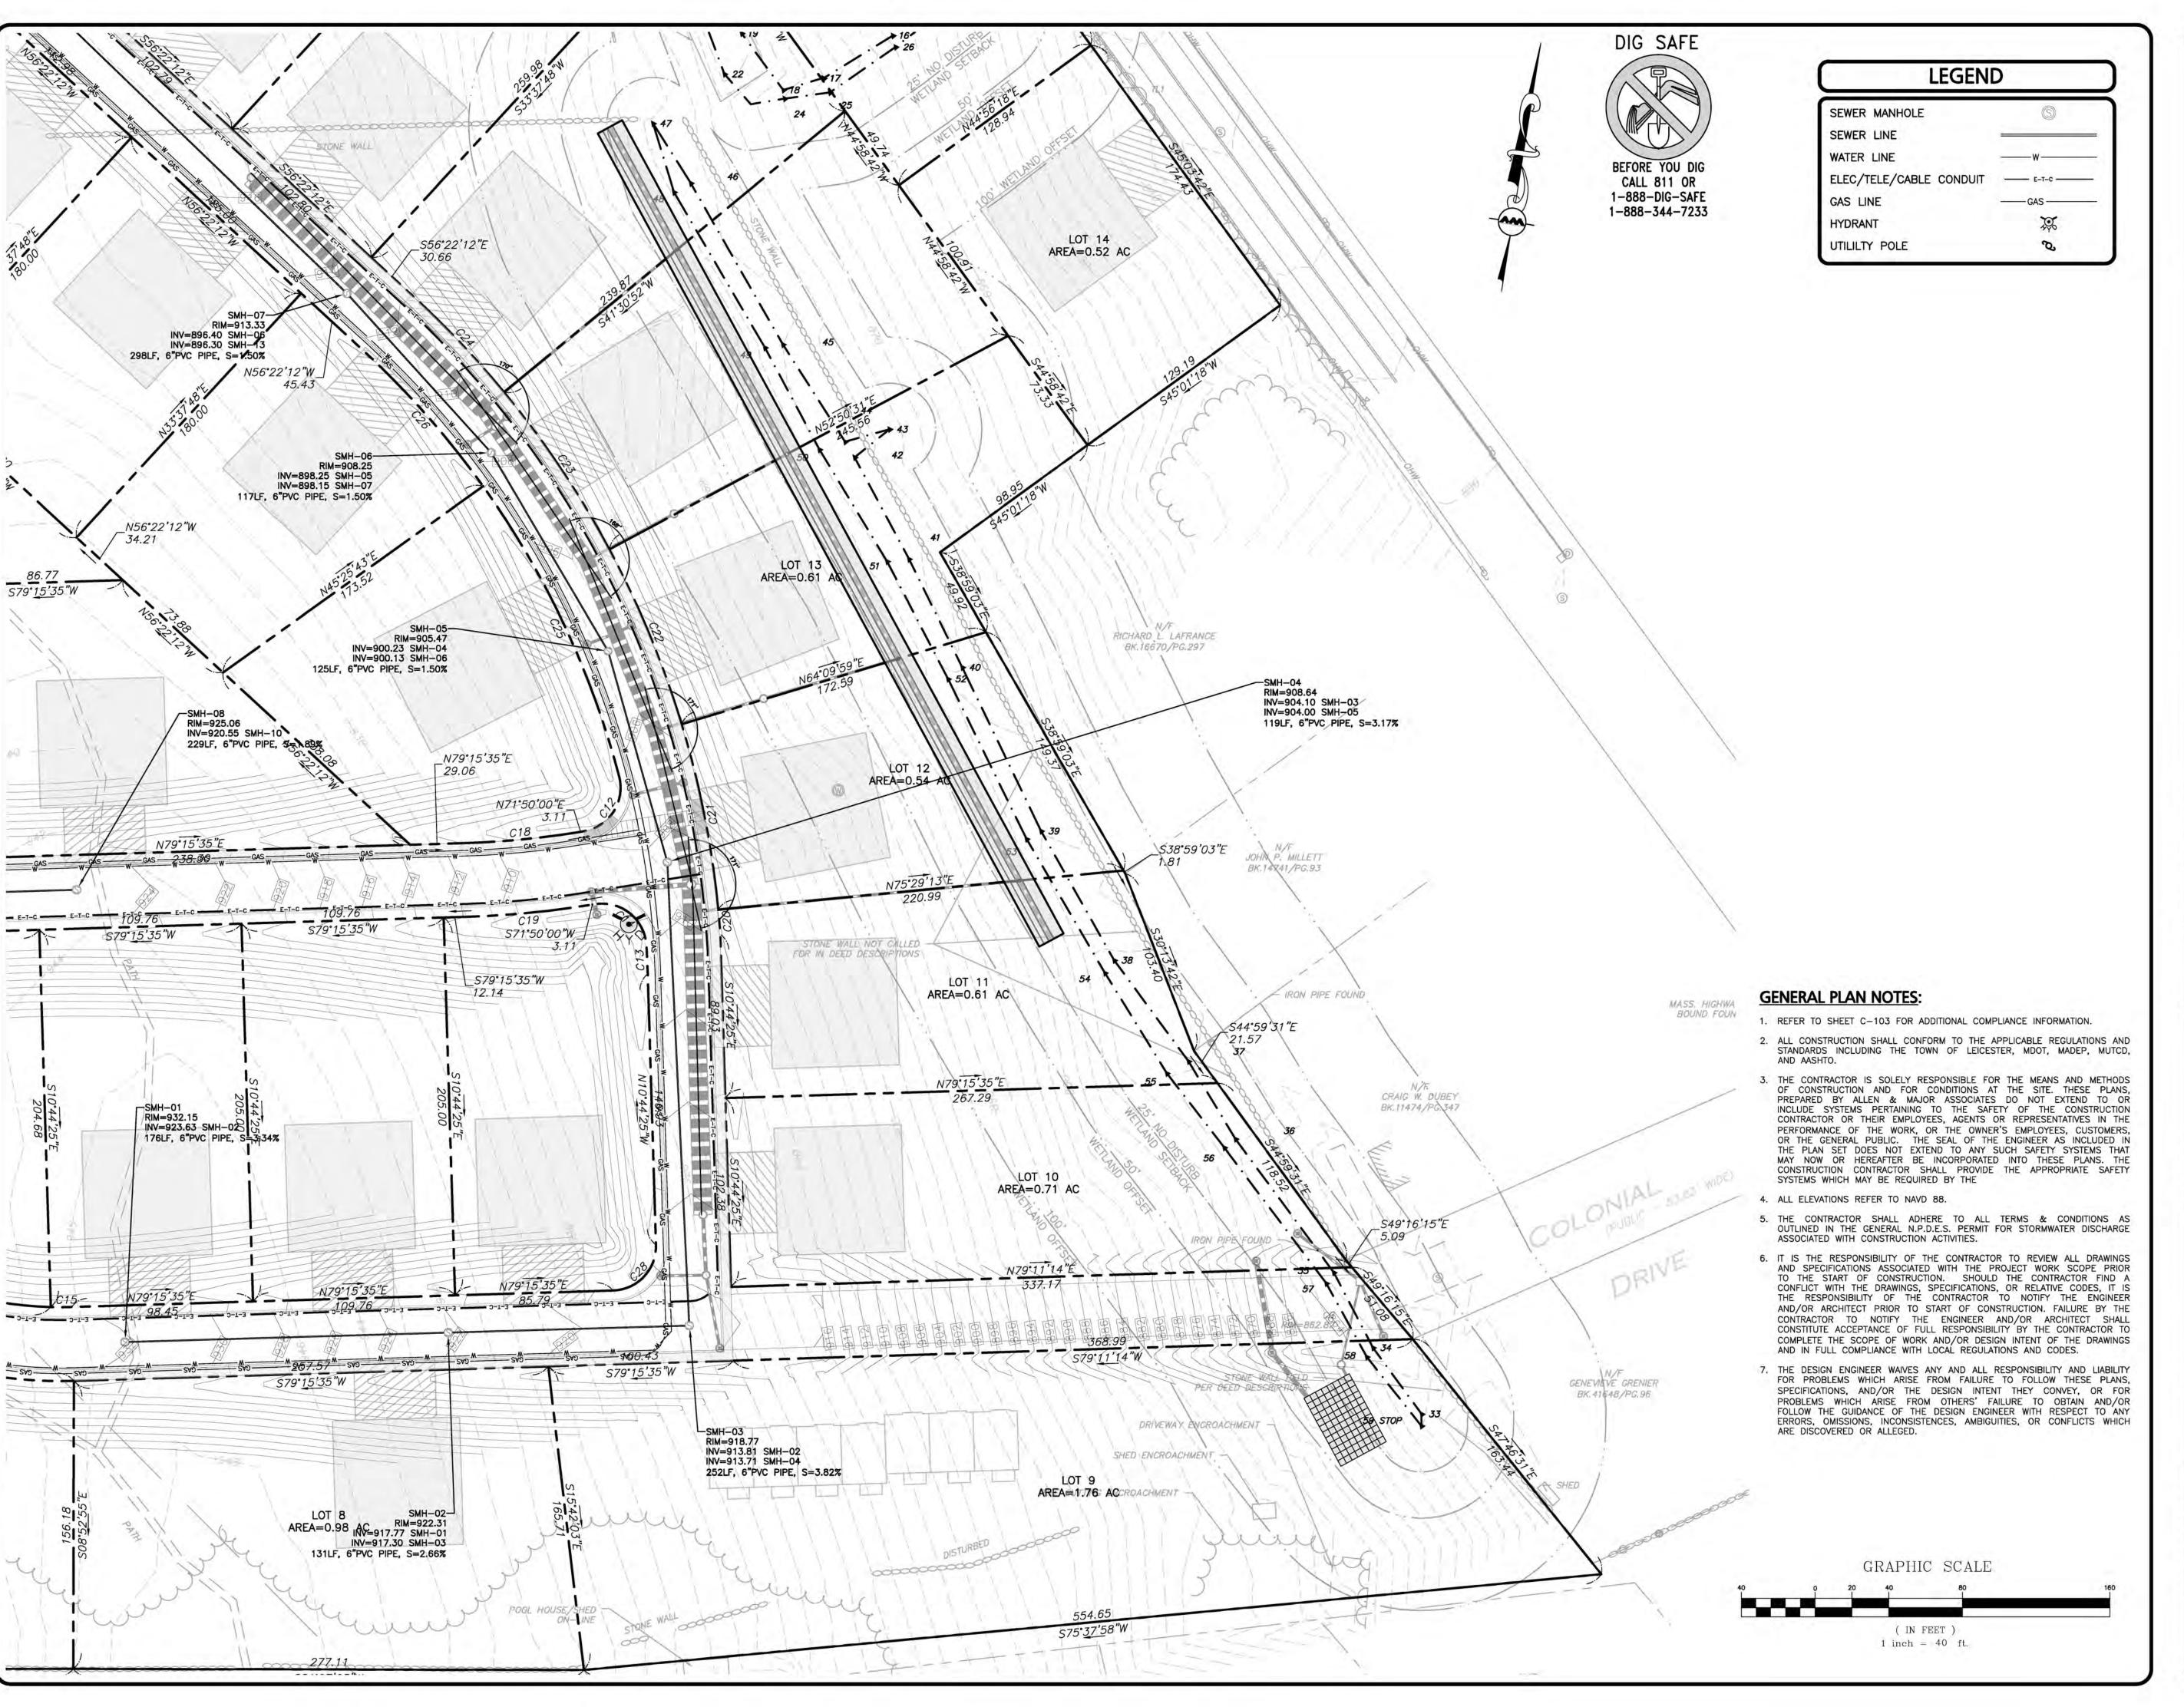
DRAWING TITLE: **GRADING & DRAINAGE** 


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TOWN CLERK - TOWN OF LEICESTER

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APPLICANT:

MKEP 770 LLC 265 SUNRISE HIGHWAY, SUITE 1368 **ROCKVILLE CENTER, NY 11570** 

PROJECT:

**SKYVIEW ESTATES RESIDENTIAL SUBDIVISION MAIN STREET** LEICESTER, MA

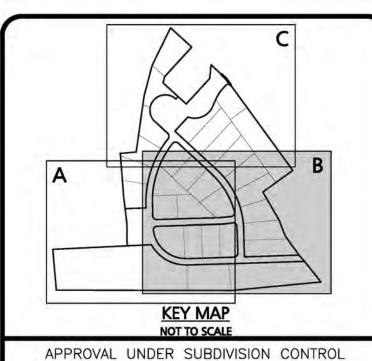2889-01 DATE: PROJECT NO. 07-16-21 SCALE: 1" = ##' DWG. : C-2889-01\_Utilities

**DESIGNED BY:** SM CHECKED BY:



### ASSOCIATES, INC.

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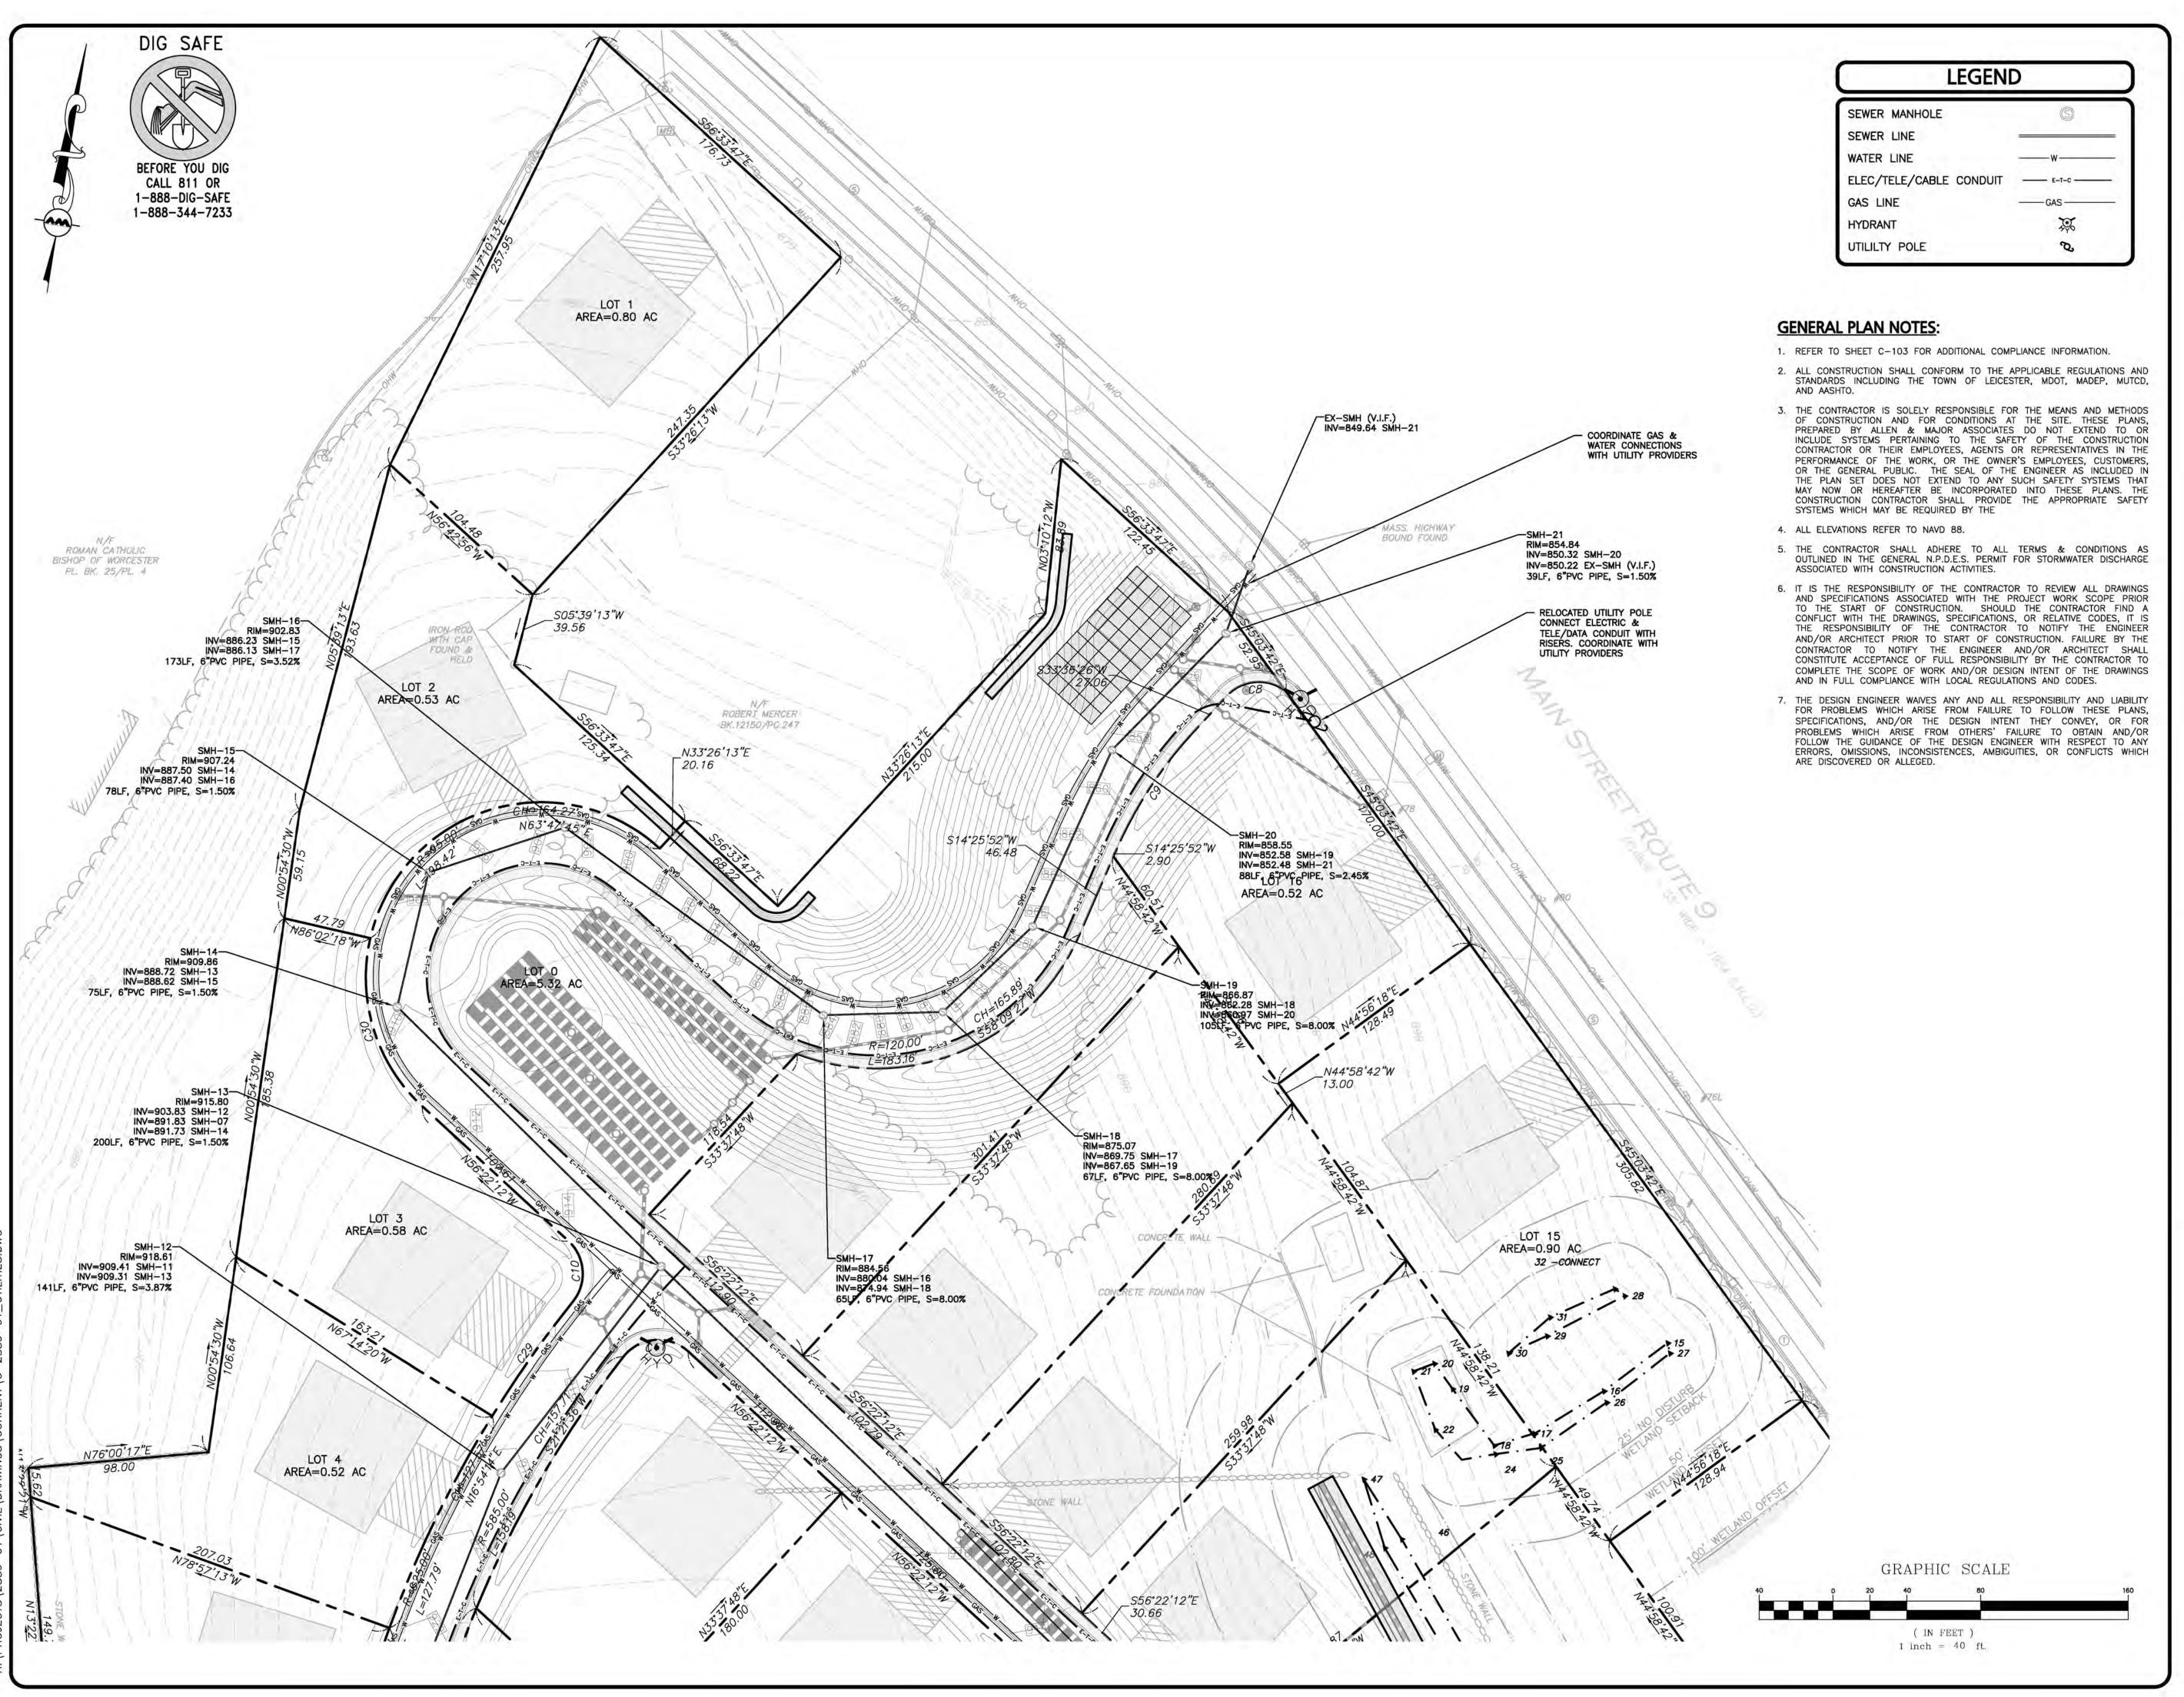
DRAWING TITLE: **UTILITY PLAN** 


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SHEET No.

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LEICESTER PLANNING BOARD

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TOWN CLERK - TOWN OF LEICESTER

#### **ISSUED FOR** PLANNING BOARD REVIEW **JULY 16, 2021**

PROFESSIONAL ENGINEER FOR ALLEN & MAJOR ASSOCIATES, INC.

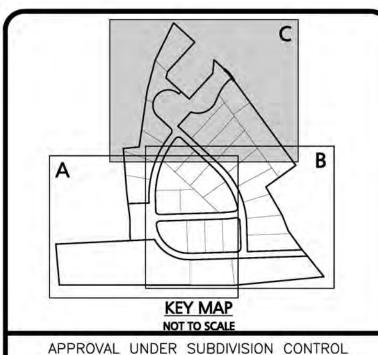REV	DATE	DESCRIPTION

MKEP 770 LLC

265 SUNRISE HIGHWAY, SUITE 1368 **ROCKVILLE CENTER, NY 11570** 

PROJECT:

PROJECT NO.

**SKYVIEW ESTATES RESIDENTIAL SUBDIVISION** MAIN STREET LEICESTER, MA

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SIGNED BY:	SM	CHECKED BY:	MA

07-16-21

2889-01 DATE:



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100 COMMERCE WAY, SUITE 5
WOBURN MA 01801

TEL: (781) 935-6889 FAX: (781) 935-2896


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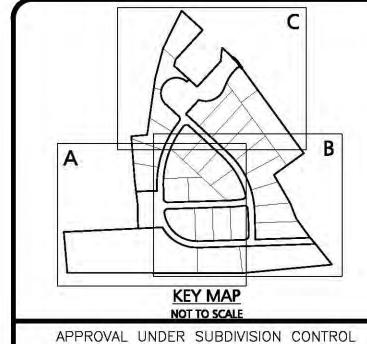
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AWING TITLE:	SHEET No.
UTILITY PLAN	C-103

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LEICESTER PLANNING BOARD

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TOWN CLERK - TOWN OF LEICESTER

## ISSUED FOR PLANNING BOARD REVIEW JULY 16, 2021

PROFESSIONAL ENGINEER FOR ALLEN & MAJOR ASSOCIATES, INC.

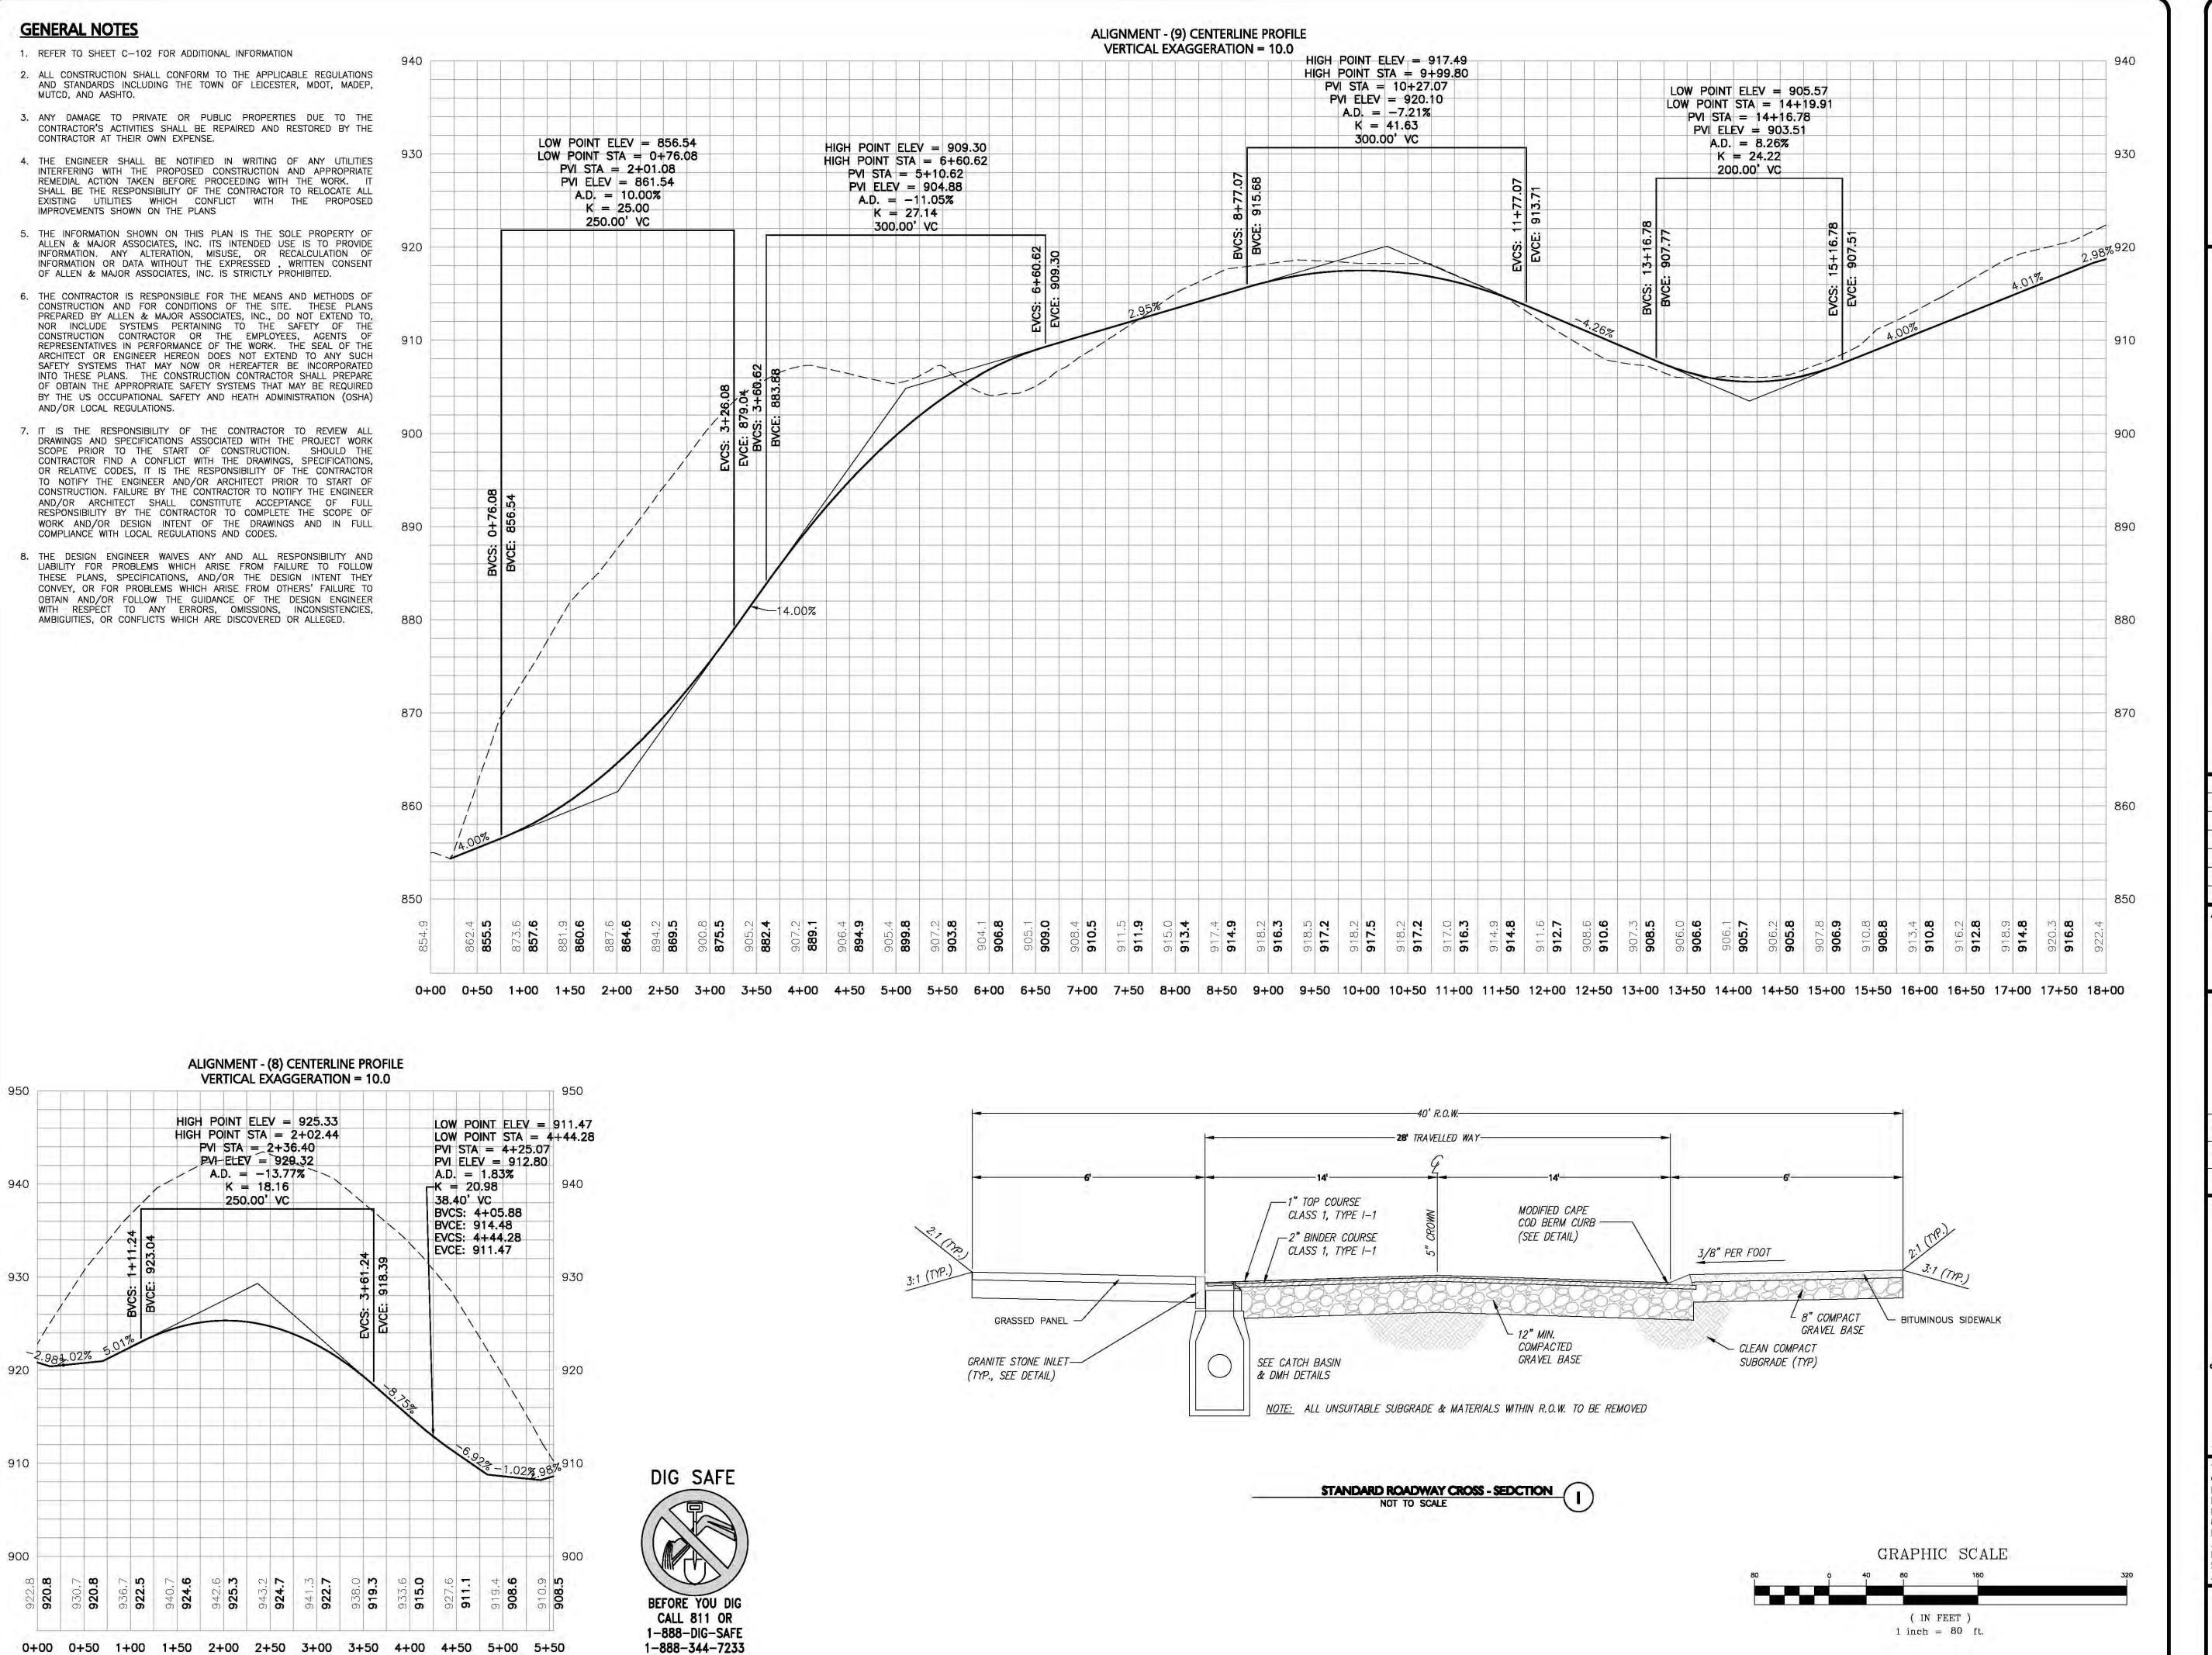REV	DATE	DESCRIPTION	

APPLICANT:

MKEP 770 LLC 265 SUNRISE HIGHWAY, SUITE 1368 ROCKVILLE CENTER, NY 11570

PROJECT:

SKYVIEW ESTATES
RESIDENTIAL SUBDIVISION
MAIN STREET
LEICESTER, MA

PROJECT NO. 2889-01 DATE:

SM CHECKED BY:

07-16-21

SCALE: 1" = 80' DWG. : C-2889-01\_Grading & Drainag

DESIGNED BY:



ASSOCIATES, INC.

civil engineering • land surveying
environmental consulting • landscape architecture

mental consulting ◆ landscape architectu w w w . a l l e n m a j o r . c o m 100 COMMERCE WAY, SUITE 5 WOBURN MA 01801 TEL: (781) 935-6889 FAX: (781) 935-2896

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DRAWING TITLE:

SHEET No.

ROADWAY PROFILES ALIGNMENT (8) & (9)


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#### **GENERAL NOTES**


- 1. REFER TO SHEET C-102 FOR ADDITIONAL INFORMATION
- 2. ALL CONSTRUCTION SHALL CONFORM TO THE APPLICABLE REGULATIONS AND STANDARDS INCLUDING THE TOWN OF LEICESTER, MDOT, MADEP, MUTCD, AND AASHTO.
- 3. ANY DAMAGE TO PRIVATE OR PUBLIC PROPERTIES DUE TO THE CONTRACTOR'S ACTIVITIES SHALL BE REPAIRED AND RESTORED BY THE CONTRACTOR AT THEIR OWN EXPENSE.
- 4. THE ENGINEER SHALL BE NOTIFIED IN WRITING OF ANY UTILITIES INTERFERING WITH THE PROPOSED CONSTRUCTION AND APPROPRIATE REMEDIAL ACTION TAKEN BEFORE PROCEEDING WITH THE WORK. IT SHALL BE THE RESPONSIBILITY OF THE CONTRACTOR TO RELOCATE ALL EXISTING UTILITIES WHICH CONFLICT WITH THE PROPOSED IMPROVEMENTS SHOWN ON THE PLANS
- 5. THE INFORMATION SHOWN ON THIS PLAN IS THE SOLE PROPERTY OF ALLEN & MAJOR ASSOCIATES, INC. ITS INTENDED USE IS TO PROVIDE INFORMATION. ANY ALTERATION, MISUSE, OR RECALCULATION OF INFORMATION OR DATA WITHOUT THE EXPRESSED, WRITTEN CONSENT OF ALLEN & MAJOR ASSOCIATES, INC. IS STRICTLY PROHIBITED.
- 6. THE CONTRACTOR IS RESPONSIBLE FOR THE MEANS AND METHODS OF CONSTRUCTION AND FOR CONDITIONS OF THE SITE. THESE PLANS PREPARED BY ALLEN & MAJOR ASSOCIATES, INC., DO NOT EXTEND TO, NOR INCLUDE SYSTEMS PERTAINING TO THE SAFETY OF THE CONSTRUCTION CONTRACTOR OR THE EMPLOYEES, AGENTS OF REPRESENTATIVES IN PERFORMANCE OF THE WORK. THE SEAL OF THE ARCHITECT OR ENGINEER HEREON DOES NOT EXTEND TO ANY SUCH SAFETY SYSTEMS THAT MAY NOW OR HEREAFTER BE INCORPORATED INTO THESE PLANS. THE CONSTRUCTION CONTRACTOR SHALL PREPARE OF OBTAIN THE APPROPRIATE SAFETY SYSTEMS THAT MAY BE REQUIRED BY THE US OCCUPATIONAL SAFETY AND HEATH ADMINISTRATION (OSHA) AND/OR LOCAL REGULATIONS.
- 7. IT IS THE RESPONSIBILITY OF THE CONTRACTOR TO REVIEW ALL DRAWINGS AND SPECIFICATIONS ASSOCIATED WITH THE PROJECT WORK SCOPE PRIOR TO THE START OF CONSTRUCTION. SHOULD THE CONTRACTOR FIND A CONFLICT WITH THE DRAWINGS, SPECIFICATIONS, OR RELATIVE CODES, IT IS THE RESPONSIBILITY OF THE CONTRACTOR TO NOTIFY THE ENGINEER AND/OR ARCHITECT PRIOR TO START OF CONSTRUCTION. FAILURE BY THE CONTRACTOR TO NOTIFY THE ENGINEER AND/OR ARCHITECT SHALL CONSTITUTE ACCEPTANCE OF FULL RESPONSIBILITY BY THE CONTRACTOR TO COMPLETE THE SCOPE OF WORK AND/OR DESIGN INTENT OF THE DRAWINGS AND IN FULL COMPLIANCE WITH LOCAL REGULATIONS AND CODES.
- 8. THE DESIGN ENGINEER WAIVES ANY AND ALL RESPONSIBILITY AND LIABILITY FOR PROBLEMS WHICH ARISE FROM FAILURE TO FOLLOW THESE PLANS, SPECIFICATIONS, AND/OR THE DESIGN INTENT THEY CONVEY, OR FOR PROBLEMS WHICH ARISE FROM OTHERS' FAILURE TO OBTAIN AND/OR FOLLOW THE GUIDANCE OF THE DESIGN ENGINEER WITH RESPECT TO ANY ERRORS, OMISSIONS, INCONSISTENCIES, AMBIGUITIES, OR CONFLICTS WHICH ARE DISCOVERED OR ALLEGED.




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TOWN CLERK - TOWN OF LEICESTER

# ISSUED FOR PLANNING BOARD REVIEW JULY 16, 2021

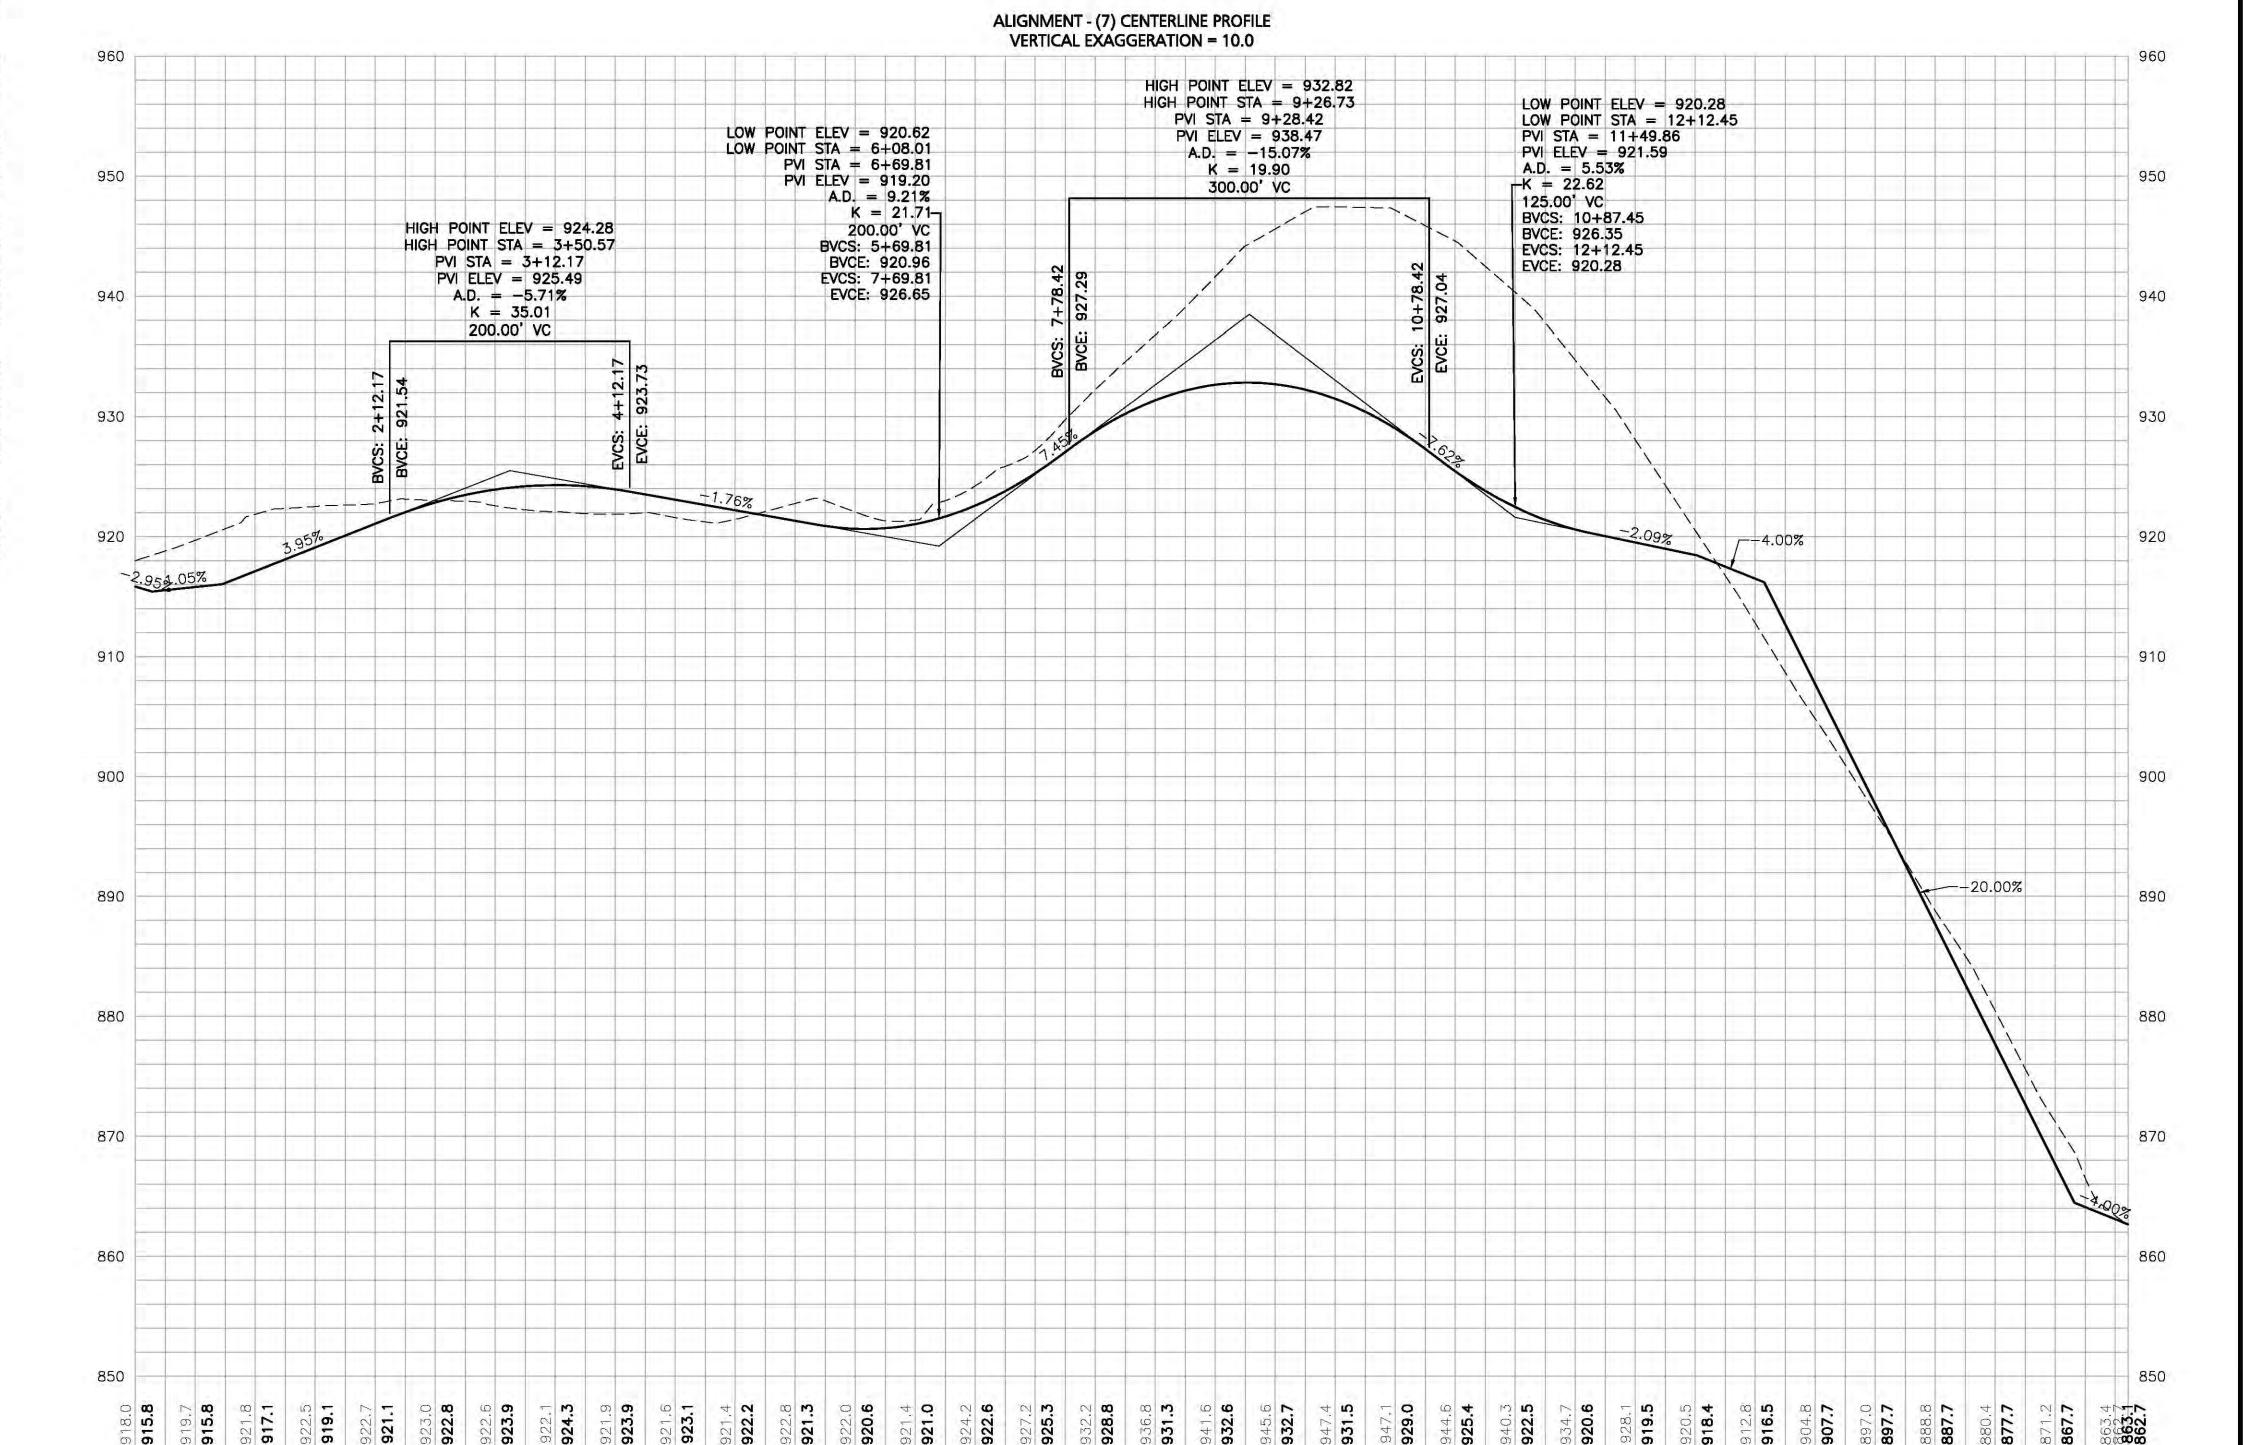PROFESSIONAL ENGINEER FOR ALLEN & MAJOR ASSOCIATES, INC.

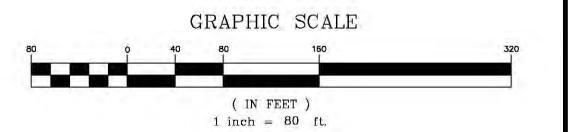
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REV	DATE	DESCRIPTION	
APPLICAN	T:		

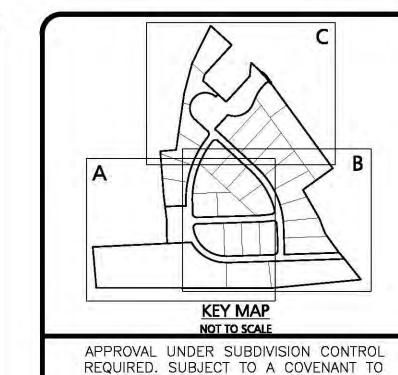MKEP 770 LLC 265 SUNRISE HIGHWAY, SUITE 1368 ROCKVILLE CENTER, NY 11570

SKYVIEW ESTATES
RESIDENTIAL SUBDIVISION
MAIN STREET
LEICESTER, MA

PROJECT NO. 2889-01 DATE: 07-16-21

SCALE: 1" = 80' DWG.: C2889-01\_Grading & Drainage

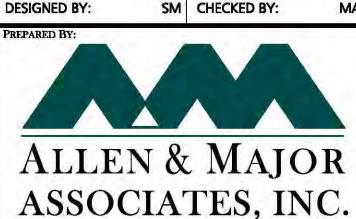

civil engineering ◆ land surveying environmental consulting ◆ landscape architecture w w w . a l l e n m a j o r . c o m 100 COMMERCE WAY, SUITE 5 WOBURN MA 01801 TEL: (781) 935-6889

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FAX: (781) 935-2896

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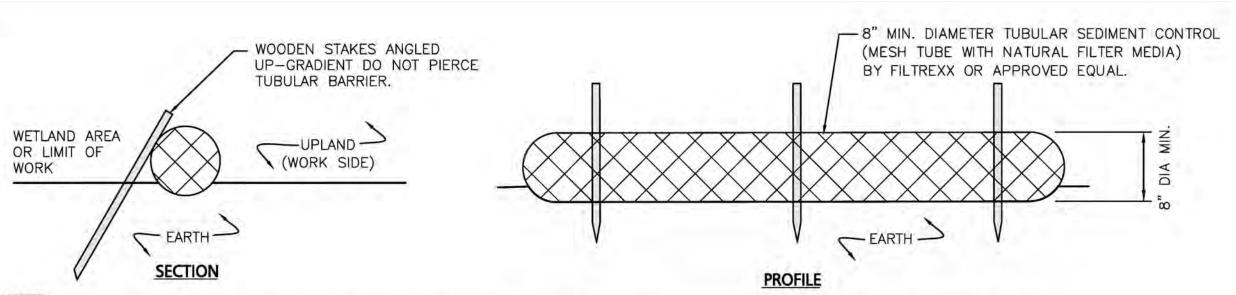
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ALIGNMENT (7)
PROFILE

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sociates, Inc. 16 OF 19


R:\PROJECTS\2889-01\CIVIL\DRAWINGS\CURRENT\C-2889-01\_GRADING & DRAIN




1. TUBULAR SEDIMENT CONTROL SHALL BE 8" MIN. DIAMETER MESH TUBE WITH NATURAL FILTER MEDIA BY FILTREXX OR APPROVED EQUAL.

- 2. ALL MATERIALS TO MEET MANUFACTURERS SPECIFICATIONS.
- 3. INSTALL WOODEN STAKES ANGLED UP-GRADIENT EVERY 8' ON CENTER
- 4. OVERLAP TUBULAR BARRIER SEGMENTS A MINIMUM OF 12".
- 5. THE CONTRACTOR SHALL MAINTAIN THE TUBULAR BARRIERS IN A FUNCTIONAL CONDITION AT ALL TIMES. THE CONTROLS SHALL BE ROUTINELY INSPECTED BY THE CONTRACTOR.
- 6. WHERE THE TUBULAR BARRIERS REQUIRE REPAIR OR SEDIMENT REMOVAL, IT WILL BE COMPLETED BY THE CONTRACTOR AT NO ADDITIONAL COST.
- 7. AT A MINIMUM, THE CONTRACTOR SHALL REMOVE SEDIMENTS COLLECTED AT THE BASE WHEN THEY REACH 1/3 THE EXPOSED HEIGHT OF THE BARRIER.



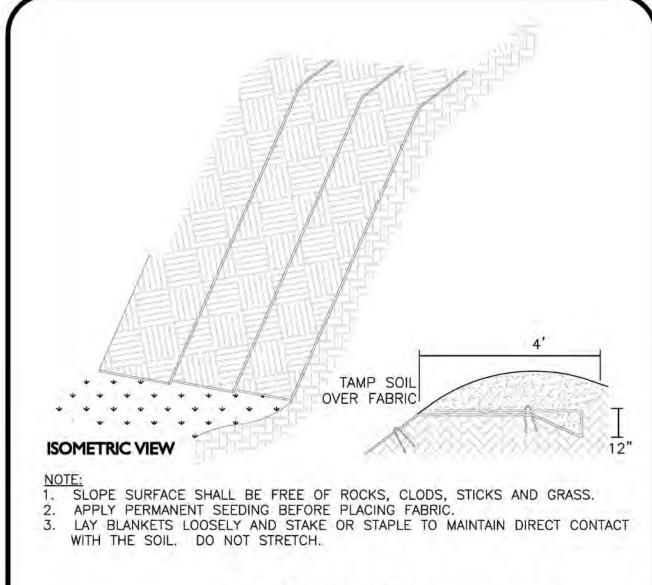

**EROSION CONTROL FABRIC** NOT TO SCALE

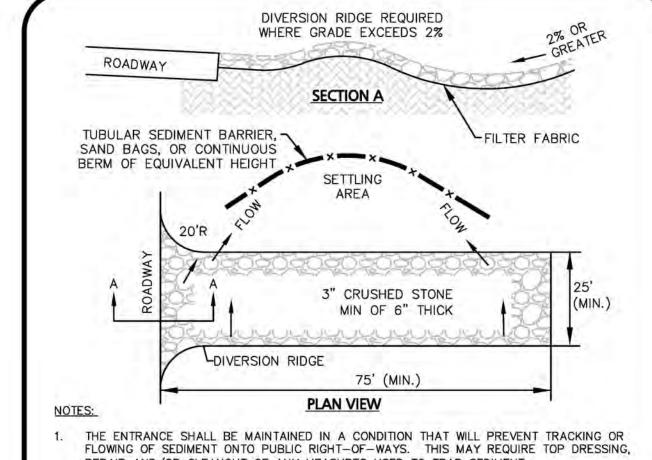

- REPAIR AND/OR CLEANOUT OF ANY MEASURES USED TO TRAP SEDIMENT.
- WHEN NECESSARY, WHEELS SHALL BE CLEANED PRIOR TO ENTERING THE PUBLIC RIGHT-OF-WAY.
- WHEN WASHING IS REQUIRED. IT SHALL BE DONE ON AN AREA STABILIZED WITH CRUSHED STONE THAT DRAINS INTO AN APPROVED SEDIMENT TRAP OR SEDIMENT BASIN.

STABILIZED CONSTRUCTION ENTRANCE NOT TO SCALE

 $\Diamond$ **₽** 1" REBAR FOR LIFTING AND REMOVAL -DUMP STRAP (2) -CATCH BASIN STRUCTURE

1. INSTALL SILTSACK PER

AND REPLACE AS NEEDED.

BASINS EXISTS.

MANUFACTURER'S INSTRUCTIONS AND

RECOMMENDATIONS. EMPTY OR

WHEN RESTRAINT CORD IS NO

LONGER VISIBLE. CLEAN, RINSE,

2. SILT SACKS TO BE INSTALLED

TO ENTER EXISTING & PROPOSED

DURING CONSTRUCTION OPERATIONS


WHEN THE POTENTIAL FOR SEDIMENT

REMOVE SEDIMENT FROM SILTSACK


WIDTH VARIES (SEE PLAN) 1.5" ASPHALT WALKWAY SLOPE AT 1.5% -----CONCRETE-PER FOOT MAX. (TYP.) SURFACE COURSE 6" GRAVEL BASE (MIN) 1.5" ASPHALT CONCRETE-BINDER COURSE UNDISTURBED OR COMPACTED SUBGRADE


- REFERENCE PLANS FOR ELEVATIONS.
- 2. COMPACT SOIL SUBGRADE UNIFORMLY TO AT LEAST 95% OF ASTM D 1557 LABORATORY DENSITY.
- PROOF-ROLL PREPARED SUBGRADE TO IDENTIFY SOFT POCKETS AND AREAS OF EXCESS YIELDING. EXCAVATE SOFT SPOTS, UNSATISFACTORY SOILS, AND AREAS OF EXCESSIVE PUMPING OR RUTTING, AS DETERMINED BY GEOTECHNICAL ENGINEER AND REPLACE WITH COMPACTED BACKFILL OR FILL AS DIRECTED.
- CONTRACTOR SHALL COORDINATE SURFACE, BINDER, AND BASE COURSES WITH GEOTECHNICAL OR SOILS REPORT. REFER TO REPORT FOR RECOMMENDATIONS FOR LOCAL SOILS OR DRAINAGE CONDITIONS AND/OR METHODS.
- BASE COURSE SHALL EXTEND 6 INCHES BEYOND WALKWAY EDGE WHERE WALKWAY DOES NOT ABUT DEEP CURB, WALL, STEPS, OR FIXED OBJECT.
- WALKWAY EDGES SHALL BE TAMPED WHERE WALKWAY DOES NOT ABUT DEEP CURB, WALL, STEPS, OR FIXED OBJECT.

#### **BITUMINOUS WALKWAY** (5) NOT TO SCALE

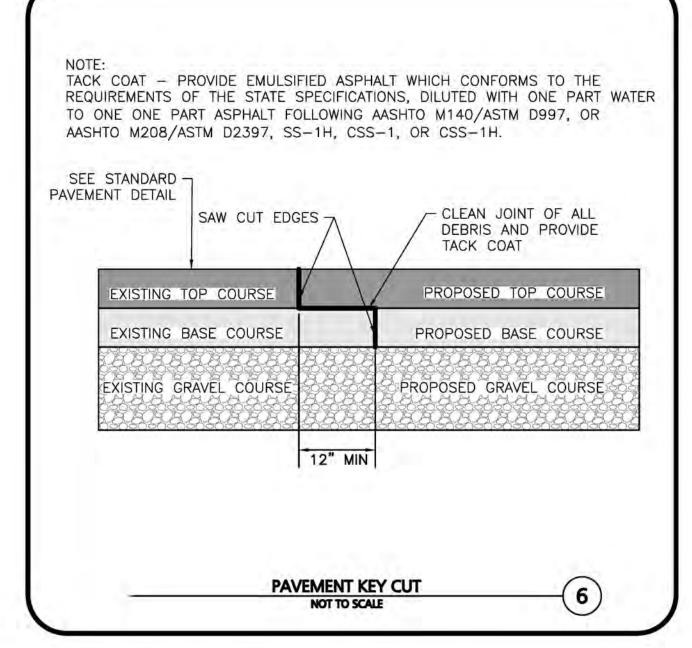

ADJUST AS REQUIRED TO FINISHED GRADE WITH

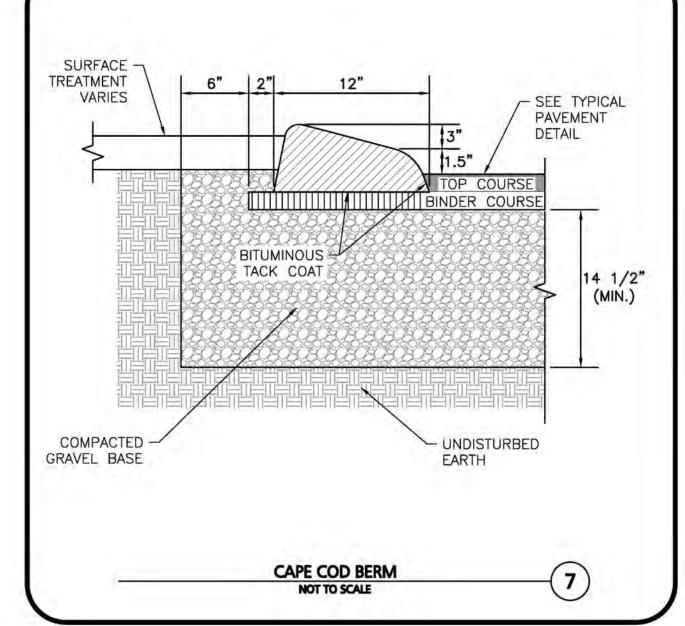

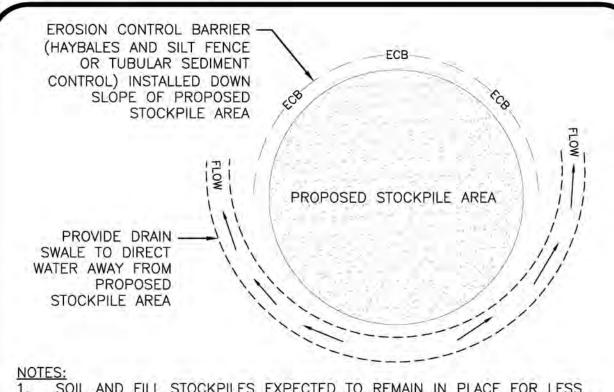


CATCH BASIN INLET PROTECTION

NOT TO SCALE

1. SOIL AND FILL STOCKPILES EXPECTED TO REMAIN IN PLACE FOR LESS THAN 90 DAYS SHALL BE COVERED WITH HAY AND MULCH (AT 100LBS/1,000 SF), OR WITH AN ANCHORED TARP WITHIN 7 DAYS OR PRIOR TO ANY RAINFALL.

2. SOIL AND FILL STOCKPILES EXPECTED TO REMAIN IN PLACE FOR 90 DAYS OR MORE SHALL BE SEEDED WITH WINTER RYE (FOR FALL SEEDING AT 3LB/1,000 SF) OR OATS (FOR SUMMER SEEDING AT 2LB/1,000 SF) AND THEN COVERED WITH HAY MULCH (AT 100LB/1,000 SF) OR AN ANCHORED TARP WITHIN 7 DAYS OR PRIOR TO ANY RAINFALL.

> STOCKPILE PROTECTION NOT TO SCALE

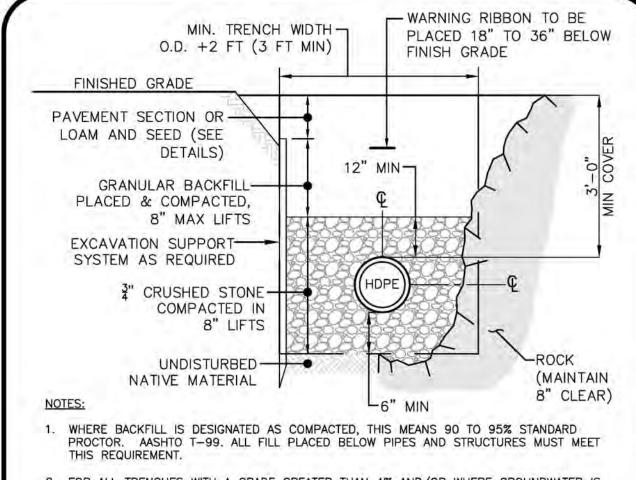

- 2. FOR ALL TRENCHES WITH A GRADE GREATER THAN 4% AND/OR WHERE GROUNDWATER IS APPARENT, INSTALL CLAY DAMS AROUND THE PIPE AT 100' INTERVALS.
- 3. CRUSHED STONE SHALL BE CLEAN, HARD, FREE FROM COATINGS AND THOROUGHLY WASHED WITH A GRADATION BY WEIGHT OF 100% PASSING A 1" SQUARE OPENING, AND 0 TO 5% PASSING A 1" SQUARE OPENING.

AIN TRENCH DETAIL	
NOT TO SCALE	\ <b>y</b> ,

12" MAX. (CONCRETE COLLAR BLOCKS ARE NOT ACCEPTABLE) ALLOWABLE ADJUSTMENT SHALL ALL BRICKS AND RINGS SHALL E BEDS OF TYPE, II M 3 1/2"	. THE MAX BE 12 INC BE SET IN	CHES. 7	COVER (H20 LOADING) SHALL HAVE PICKHOLES & THE WORD "DRAIN" IN 3" LETTERS  FINISHED GRADE
PRECAST CONCRETE SECTIONS TO CONFORM TO ASTM C-478, CONCRETE OF 4000 P.S.I. IN 28 DAYS 0.12 SQ. IN. PER LINEAR FOOT CIRCUMFERENTIAL STEEL	CONE ECCENTRIC SECTION	30" CLEAR OPENING 8"	PAVEMENT SECTION  8" CAST IRON FRAME TO BE SET ON FULL BED OF MORTAR AND SEALED WITH MORTAR.  2
REINFORCEMENT  5" MIN. WALL THICKNESS——	RISER SECTION(S)	(MIN)	KENT SEAL OR MORTAR JOINT (TYP.)  FLEXIBLE BOOT CONFORMING TO ASTM
12" OF 3/4" CRUSHED STONE PARTIALLY WRAPPED IN MIRAFI 1100N FILTER FABRIC. TUCK FABRIC 12" (MIN) UNDER EDGE OF THE STRUCTURE	BASE	6" 5" MIN	SPEC. C-443  DRAIN PIPE (DIAMETER VARIES)  OUTSIDE DIAMETER PLUS
	12"	3/4" CRUSHED STO	(SEE NOTE 2)

1. MANHOLE TO BE CAPABLE OF AASHTO H-20 LOADING WITHOUT FAILURE.

- 2. STEEL REINFORCEMENT FOR BASE SECTION BOTTOM SHALL BE A MINIMUM OF 0.12 SQ. IN./LIN. FT. (BOTH WAYS).
- 3. BASE SECTION SHALL BE

MONOLITHIC

4. ANY ADJUSTMENTS DURING CONSTRUCTION WILL BE DONE BY SAW CUTTING AND/OR CORING. THE USE OF JACKHAMMERS, HAMMERS, AND CHISELS WILL NOT BE ALLOWED.

> DRAIN MANHOLE (10)NOT TO SCALE

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_	LEICESTER	PLANNIN	G BOARD	
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WAS	RECEIVED I	DURING TH	E OF APPEA HE TWENTY FTER RECEIF	(20

APPROVAL UNDER SUBDIVISION CONTROL

TOWN CLERK - TOWN OF LEICESTER

#### **ISSUED FOR** PLANNING BOARD REVIEW **JULY 16, 2021**

PROFESSIONAL ENGINEER FOR ALLEN & MAJOR ASSOCIATES, INC.

47.0		DESIGN BURNESS
REV	DATE	DESCRIPTION
APPLICAN	IT:	

MKEP 770 LLC 265 SUNRISE HIGHWAY, SUITE 1368 **ROCKVILLE CENTER, NY 11570** 

PROJECT: **SKYVIEW ESTATES RESIDENTIAL SUBDIVISION** MAIN STREET

PROJECT NO.	2889-01	DATE: 07
SCALE:	AS SHOWN	DWG. : C-2889-01_D

LEICESTER, MA

SM CHECKED BY: **DESIGNED BY:** 



civil engineering . land surveying nvironmental consulting . landscape architecture www.allenmajor.com 100 COMMERCE WAY, SUITE 5 WOBURN MA 01801 TEL: (781) 935-6889


FAX: (781) 935-2896 WOBURN, MA . LAKEVILLE, MA . MANCHESTER, NI


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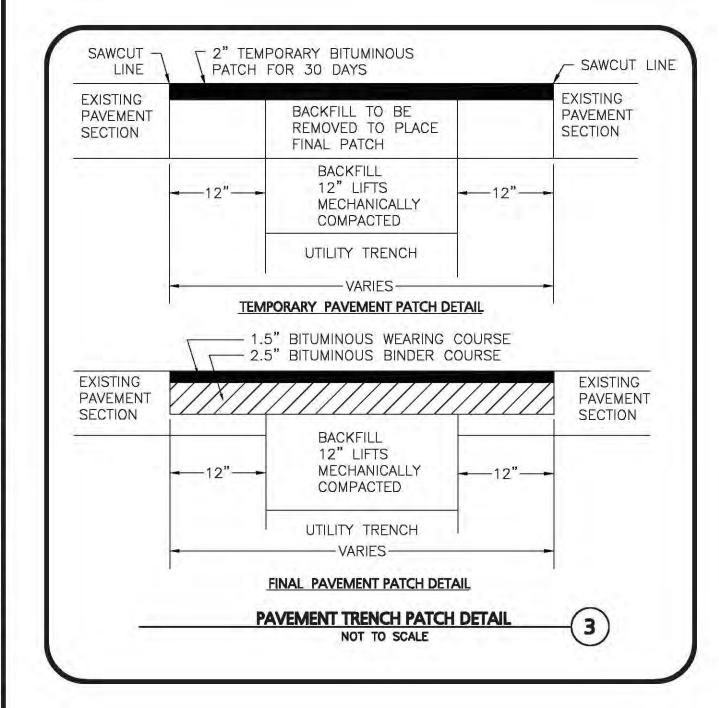
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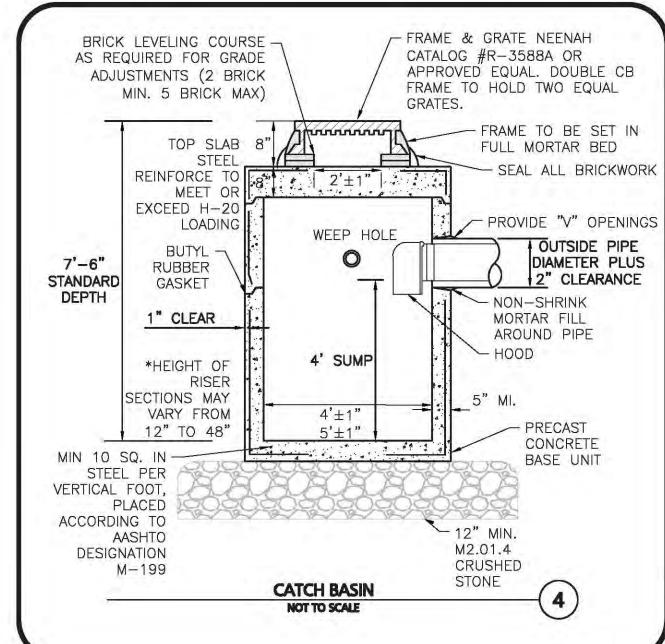
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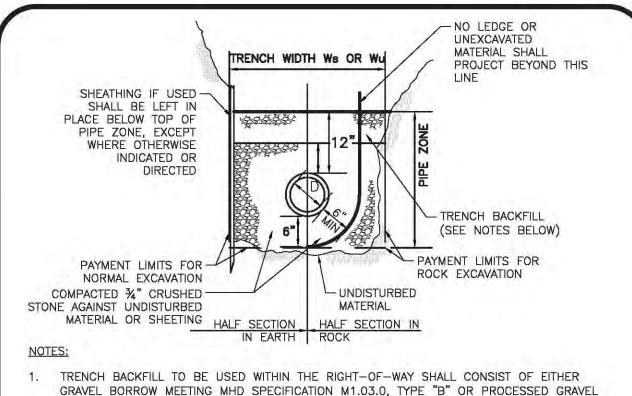
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BORROW FOR SUBBASE MEETING MHD SPECIFICATION M1.03.1.

- WHERE THE REMOVAL OF 100 SQUARE FEET OR LESS OF ASPHALT IS REQUIRED WITHIN THE RIGHT OF WAY, THEN THE TRENCH BACKFILL MATERIAL SHALL CONSIST OF CONTROLLED DENSITY FILL MEETING MHD SPECIFICATION M4.08.0, TYPE "1E" OR "2E".
- TRENCH BACKFILL MATERIAL TO BE USED OF THE RIGHT-OF-WAY MAY CONSIST OF MATERIAL GENERATED DURING EXCAVATIONS PROVIDED ALL STONES GREATER THAN 4" ARE REMOVED PRIOR TO PLACEMENT AND COMPACTION
- GRANULAR TRENCH BACKFILL MATERIAL USED WITHIN THE RIGHT-OF-WAY SHALL BE PLACED IN MAXIMUM 6" LIFTS AND MECHANICALLY COMPACTED TO A MINIMUM OF 95% OF THE MATERIAL'S MAXIMUM DRY DENSITY AND TO 90% ELSEWHERE AS DETERMINED BY ASTM D

MUNICIPAL STANDARDS) FINISHED GRADE **DETECTABLE** CURB -TRACER TAPE CURB BOX -SERVICE PIPE -SIZE VARIES 2 C.F. MIN. - 3" - GOOSENECK 60" CRUSHED STONE TO STRUCTURI CORPORATION CURB STOP (OPEN PER MUNICIPAL STANDARDS) DISTANCE VARIES WATER SERVICES LARGER THAN 1" ARE TO BE RESTRAINED TO WATER MAIN WITH APPROVED SADDLE.

TYPICAL WATER SERVICE CONNECTION

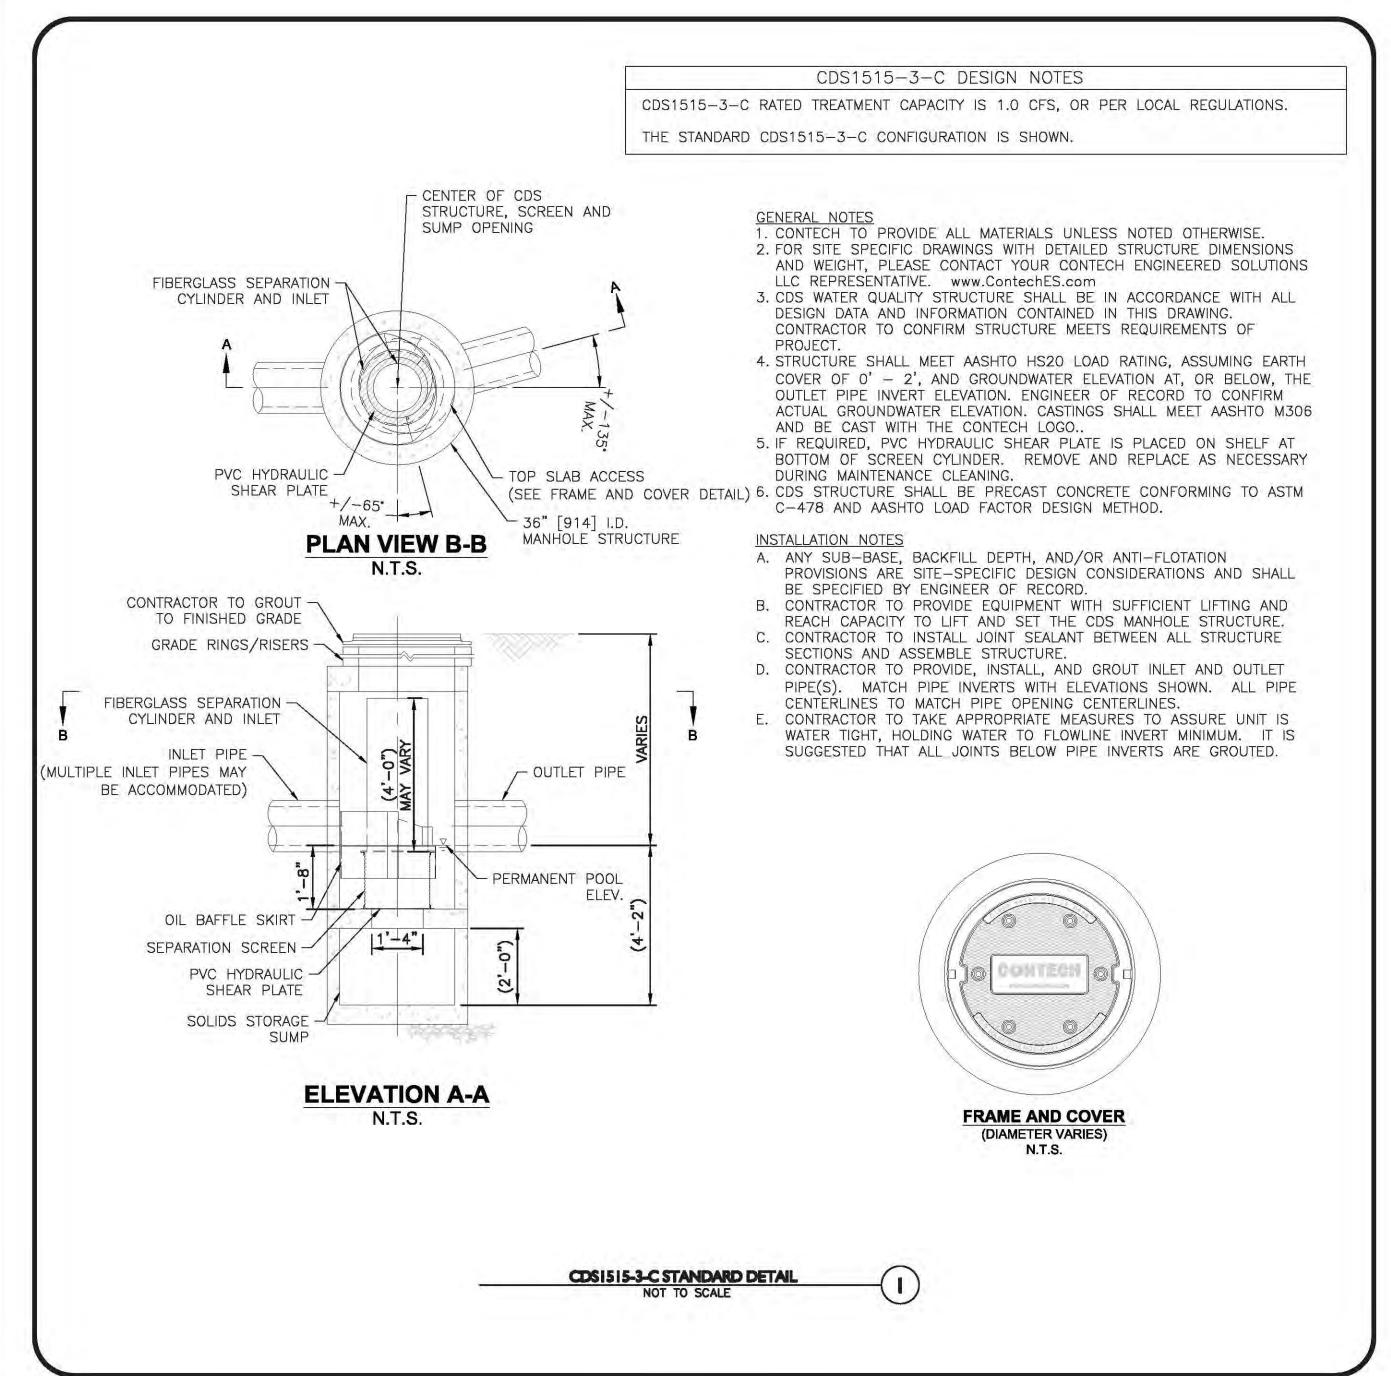NOT TO SCALE

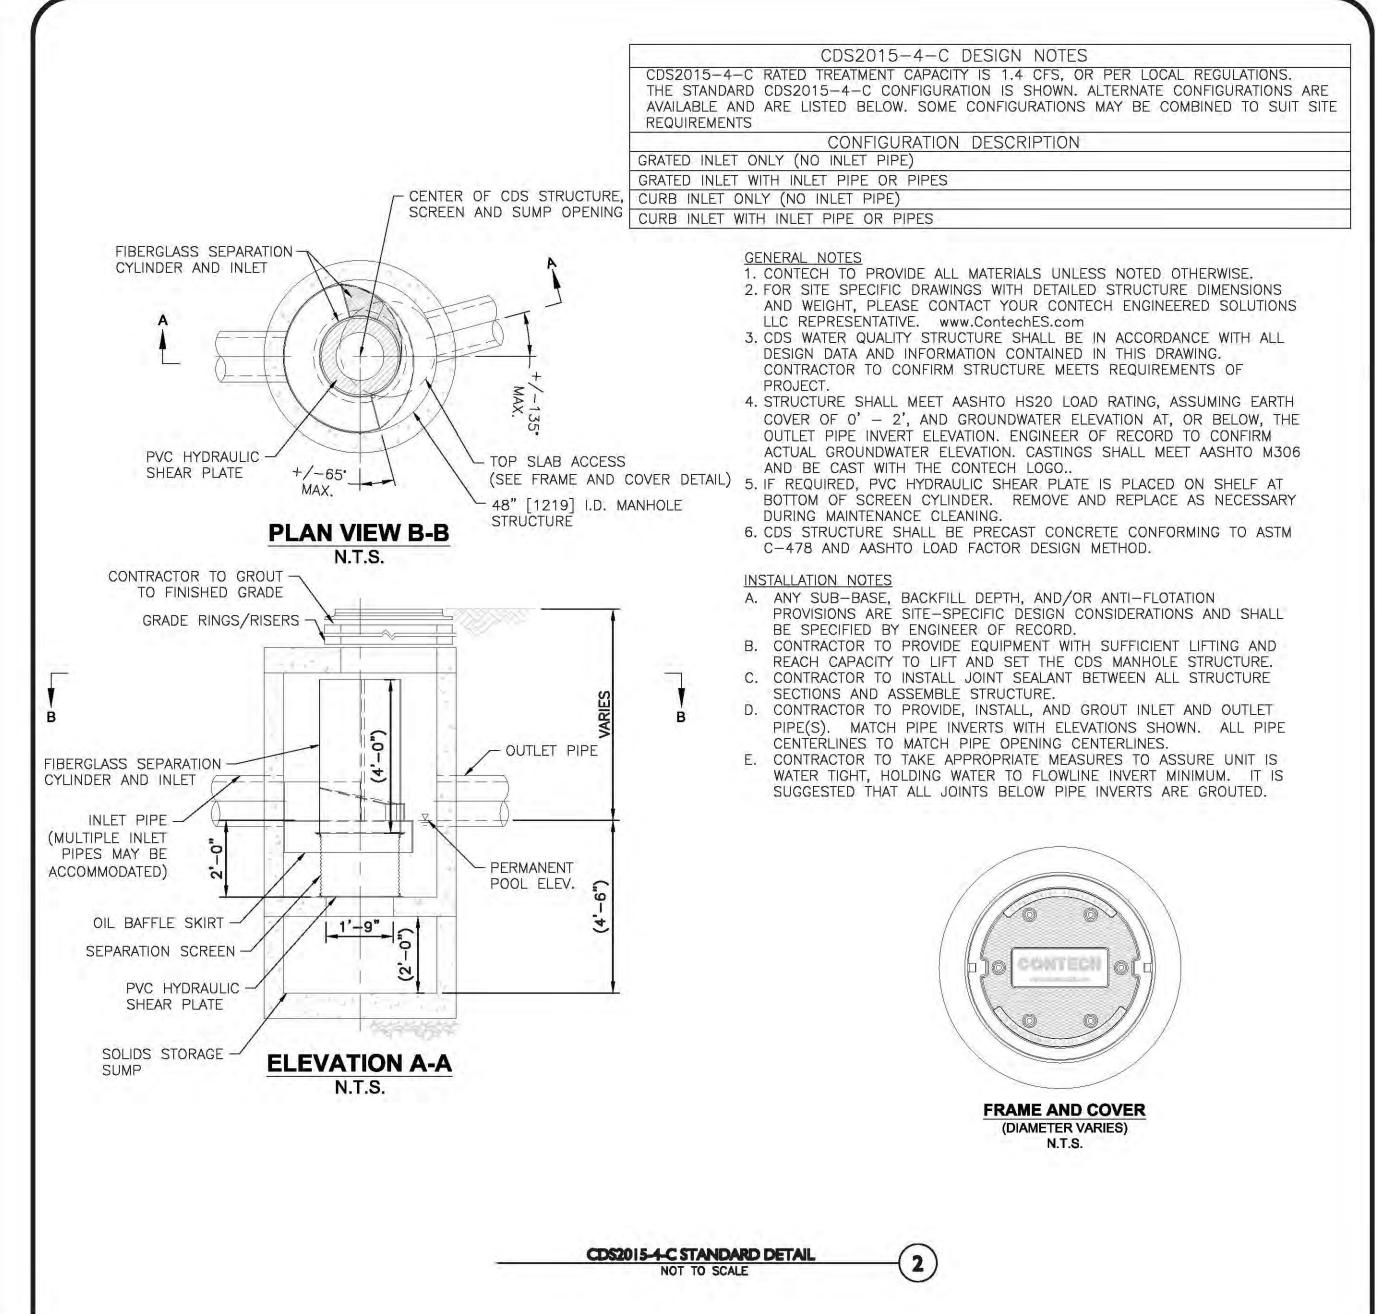18" (OR PER

TOWN CLERK — TOWN OF LEICESTER ISSUED FOR **PLANNING BOARD REVIEW JULY 16, 2021** PROFESSIONAL ENGINEER FOR ALLEN & MAJOR ASSOCIATES, INC. REV DATE DESCRIPTION APPLICANT: MKEP 770 LLC 265 SUNRISE HIGHWAY, SUITE 1368 **ROCKVILLE CENTER, NY 11570** PROJECT: **SKYVIEW ESTATES RESIDENTIAL SUBDIVISION MAIN STREET** LEICESTER, MA 2889-01 DATE: PROJECT NO. AS SHOWN DWG.: C-2889-01\_Detail DESIGNED BY: SM CHECKED BY: ALLEN & MAJOR ASSOCIATES, INC. civil engineering + land surveying environmental consulting • landscape architecture www.allenmajor.com 100 COMMERCE WAY, SUITE 5 WOBURN MA 01801 TEL: (781) 935-6889

APPROVAL UNDER SUBDIVISION CONTROL

REQUIRED. SUBJECT TO A COVENANT TO

LEICESTER PLANNING BOARD

WAS RECEIVED DURING THE TWENTY (20)

BOARD OF THE APPROVAL OF THIS PLAN

I CERTIFY THAT NO NOTICE OF APPEAL

RECORDING DAYS NEXT AFTER RECEIPT

AND OF NOTICE FROM THE PLANNING

BE RECORDED HEREWITH.

WOBURN, MA . LAKEVILLE, MA . MANCHESTER, NI THIS DRAWING HAS BEEN PREPARED IN DIGITAL FORMA CLIENT/CLIENT'S REPRESENTATIVE OR CONSULTANTS MAY B PROVIDED COPIES OF DRAWINGS AND SPECIFICATIONS FOR HIS/HER INFORMATION AND/OR SPECIFIC USE ON THIS PROJECT. DUE TO TH POTENTIAL THAT THE PROVIDED INFORMATION MAY BE MODIFIE UNINTENTIONALLY OR OTHERWISE, ALLEN & MAJOR ASSOCIATE INC. MAY REMOVE ALL INDICATION OF THE DOCUMENT AUTHORSHIP ON THE DIGITAL MEDIA. PRINTED REPRESENTATIONS O PORTABLE DOCUMENT FORMAT OF THE DRAWINGS AN SPECIFICATIONS ISSUED SHALL BE THE ONLY RECORD COPIES OF ALLEN & MAJOR ASSOCIATES, INC.'S WORK PRODUCT. SHEET No. **DRAWING TITLE:** 

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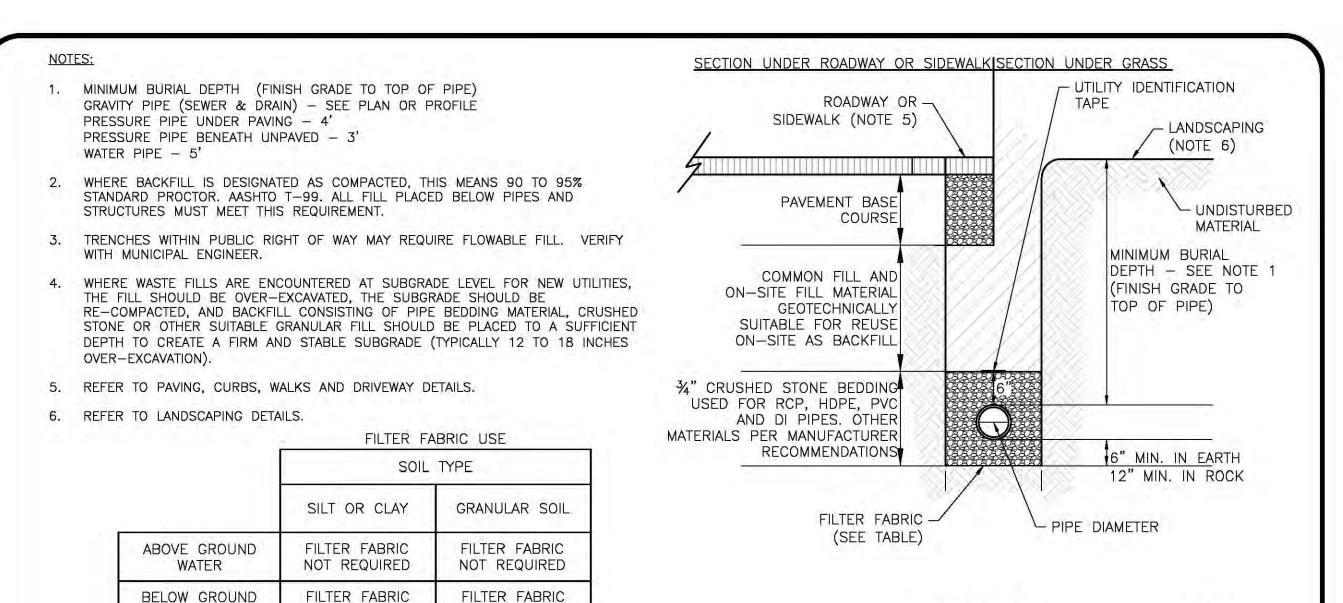
C-502 DETAILS

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07-16-21

SEWER TRENCH NOT TO SCALE




UTILITY TRENCH


NOT TO SCALE

FRAME AND COVER

(DIAMETER VARIES)

N.T.S.

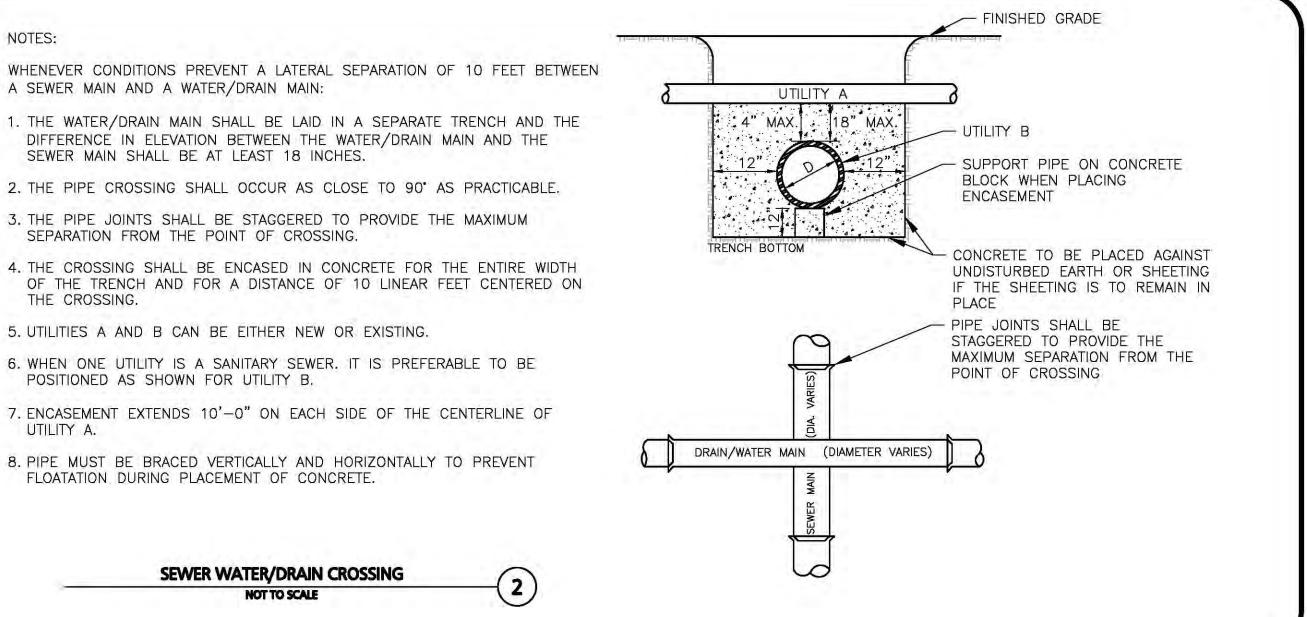


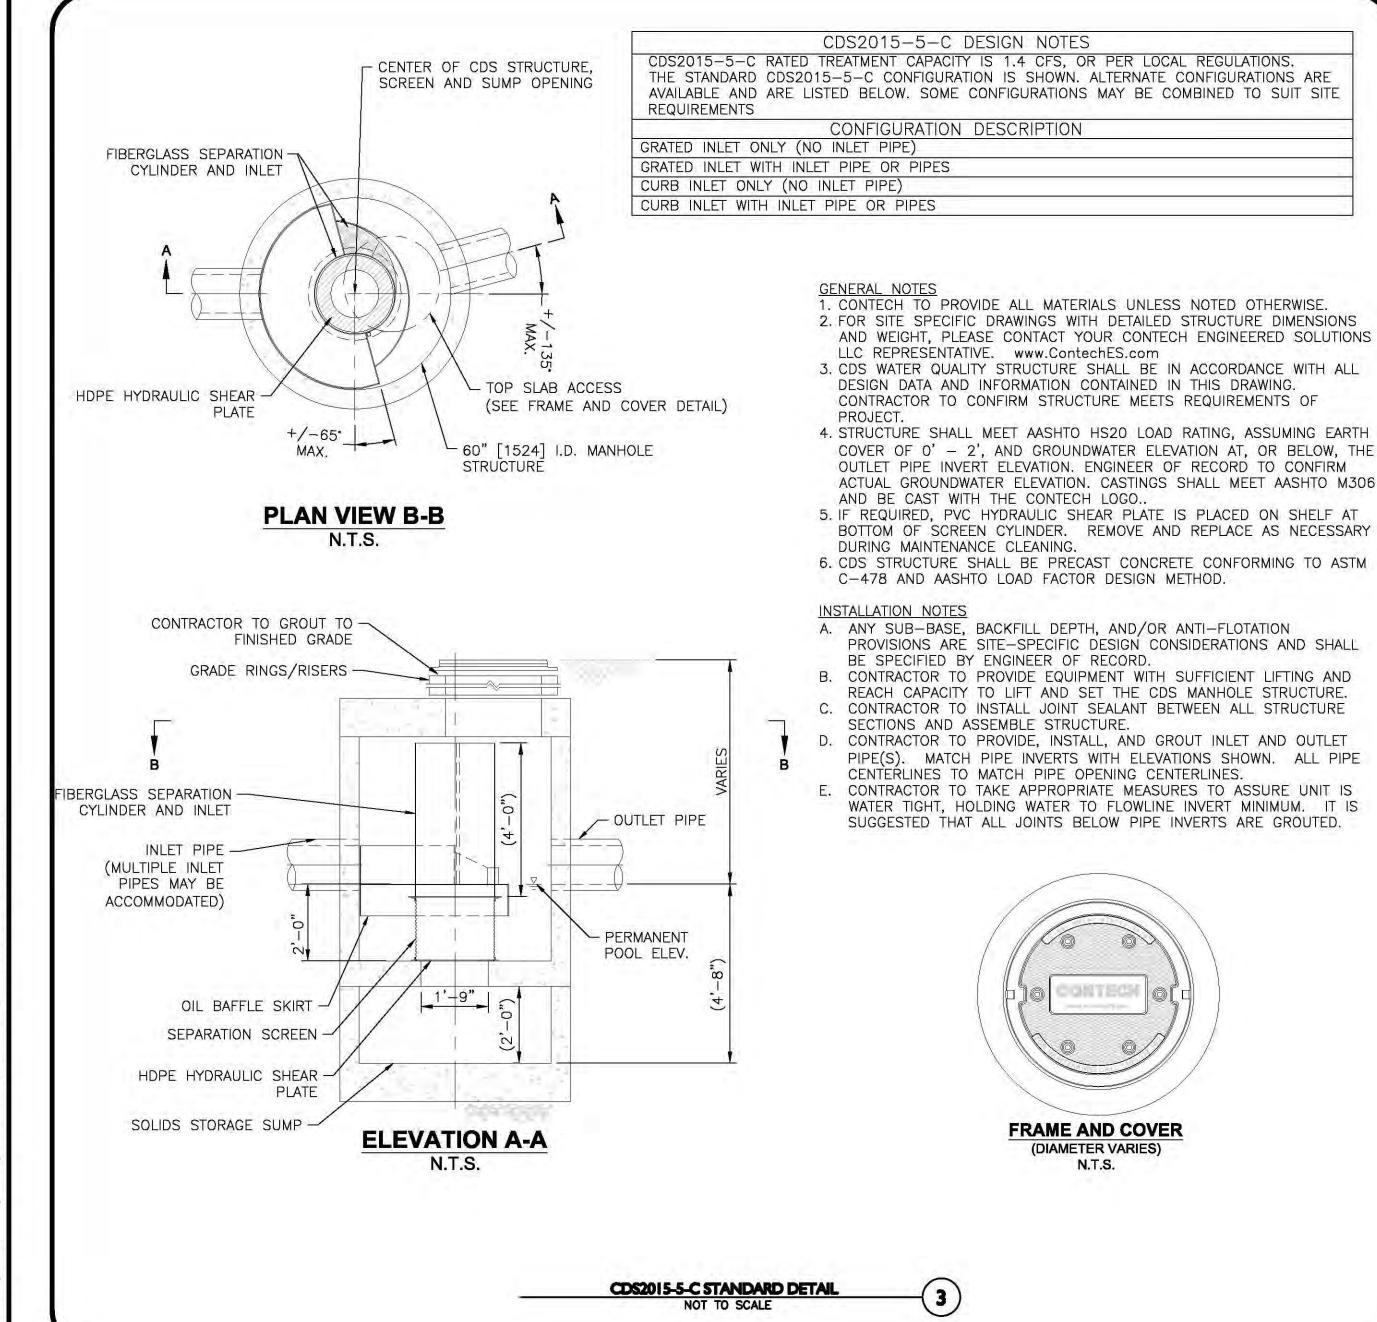



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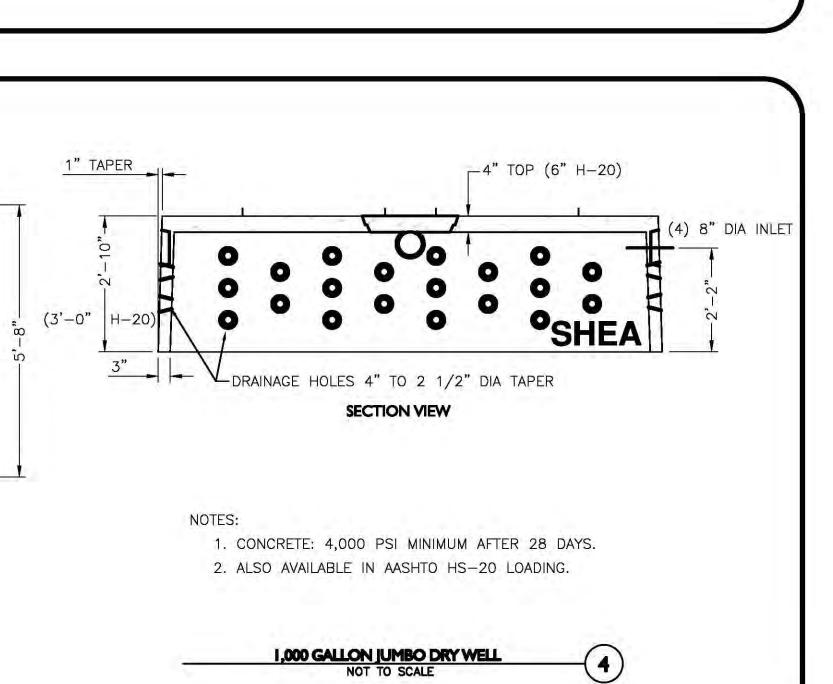
WATER

NOT REQUIRED



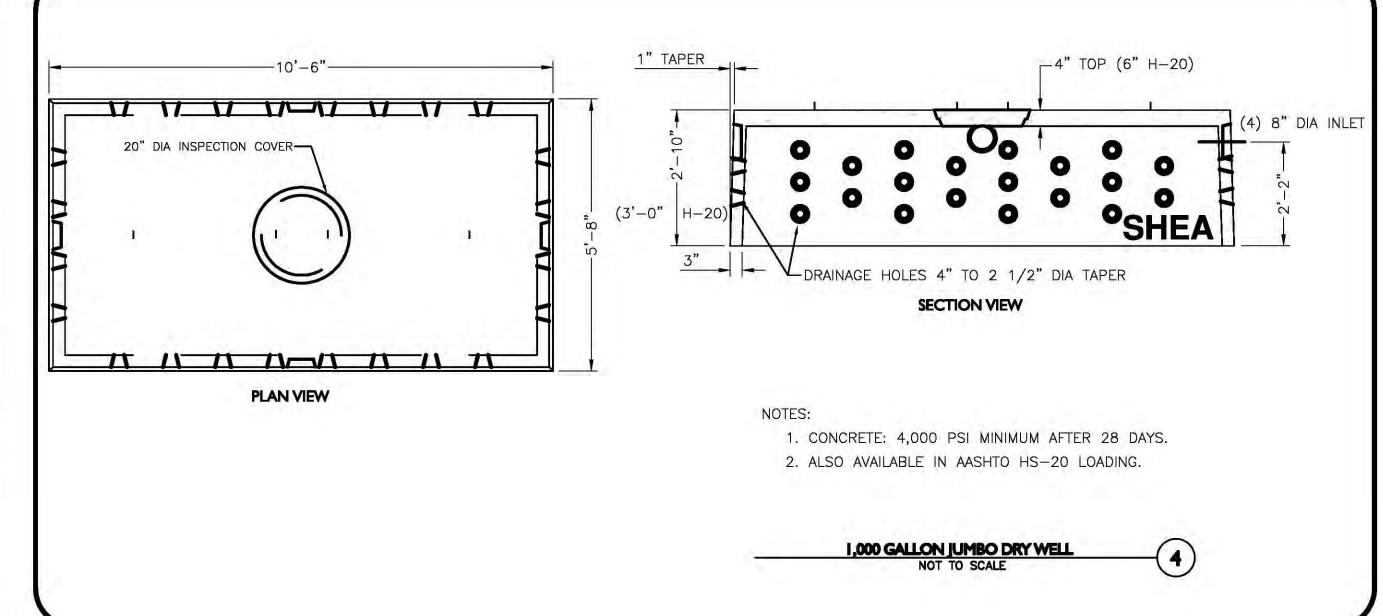

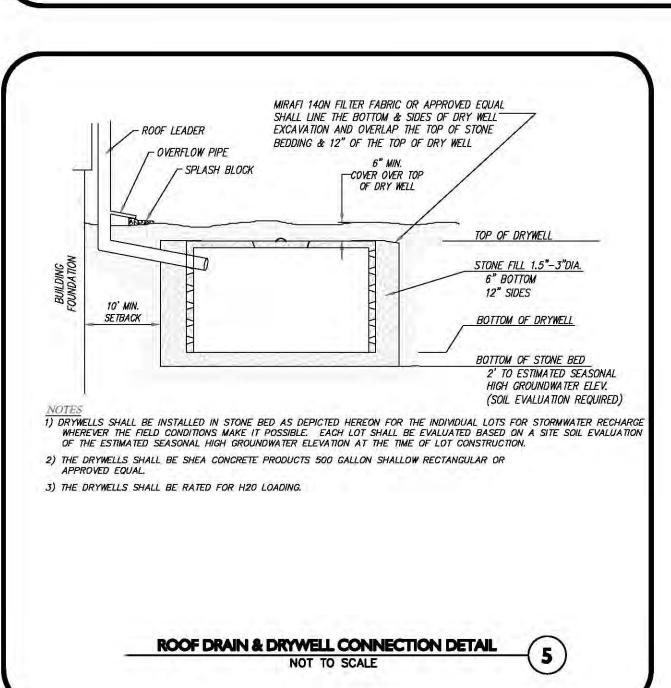

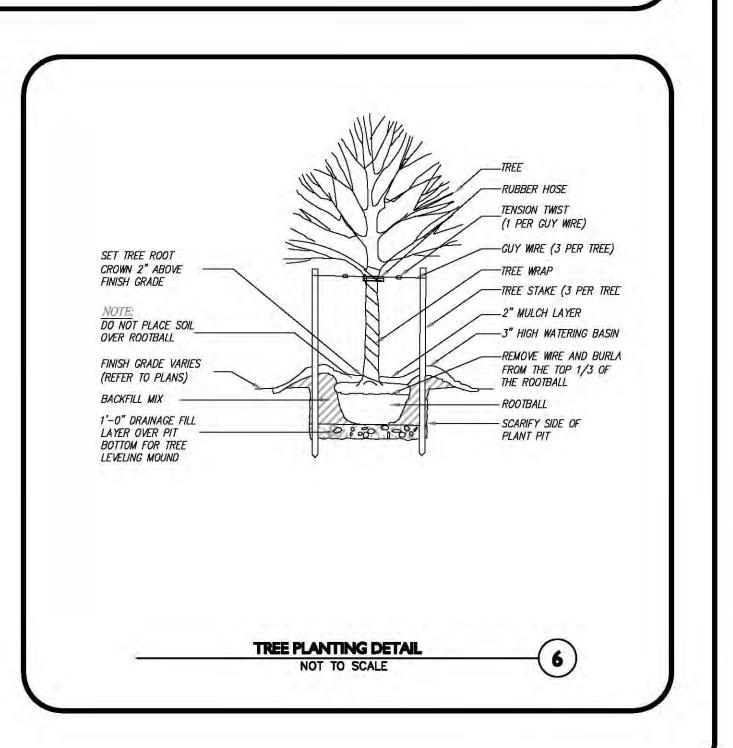

PROFESSIONAL ENGINEER FOR ALLEN & MAJOR ASSOCIATES, INC. REV DATE DESCRIPTION MKEP 770 LLC 265 SUNRISE HIGHWAY, SUITE 1368 **ROCKVILLE CENTER, NY 11570 SKYVIEW ESTATES** RESIDENTIAL SUBDIVISION **MAIN STREET** LEICESTER, MA PROJECT NO. 2889-01 DATE: 07-16-21 AS SHOWN DWG.: C-2889-01\_Details **DESIGNED BY:** SM CHECKED BY: ALLEN & MAJOR ASSOCIATES, INC. civil engineering + land surveying environmental consulting • landscape architecture www.allenmajor.com 100 COMMERCE WAY, SUITE 5 WOBURN MA 01801 TEL: (781) 935-6889 FAX: (781) 935-2896 WOBURN, MA ◆ LAKEVILLE, MA ◆ MANCHESTER, NI THIS DRAWING HAS BEEN PREPARED IN DIGITAL FORMA CLIENT/CLIENT'S REPRESENTATIVE OR CONSULTANTS MAY BE PROVIDED COPIES OF DRAWINGS AND SPECIFICATIONS FOR HIS/HER INFORMATION AND/OR SPECIFIC USE ON THIS PROJECT. DUE TO THE POTENTIAL THAT THE PROVIDED INFORMATION MAY BE MODIFIED UNINTENTIONALLY OR OTHERWISE, ALLEN & MAJOR ASSOCIATE INC. MAY REMOVE ALL INDICATION OF THE DOCUMENTS AUTHORSHIP ON THE DIGITAL MEDIA. PRINTED REPRESENTATIONS OF PORTABLE DOCUMENT FORMAT OF THE DRAWINGS AND SPECIFICATIONS ISSUED SHALL BE THE ONLY RECORD COPIES O ALLEN & MAJOR ASSOCIATES, INC.'S WORK PRODUCT. DRAWING TITLE: DETAILS Copyright ©2021 Allen & Major Associates, Inc. All Rights Reserved 19 OF 19

APPROVAL UNDER SUBDIVISION CONTROL

REQUIRED. SUBJECT TO A COVENANT TO

LEICESTER PLANNING BOARD

TOWN CLERK - TOWN OF LEICESTER

**ISSUED FOR** 

**PLANNING BOARD REVIEW** 


**JULY 16, 2021** 

APPLICANT:

PROJECT:

I CERTIFY THAT NO NOTICE OF APPEAL WAS RECEIVED DURING THE TWENTY (20) RECORDING DAYS NEXT AFTER RECEIPT AND OF NOTICE FROM THE PLANNING BOARD OF THE APPROVAL OF THIS PLAN

BE RECORDED HEREWITH.

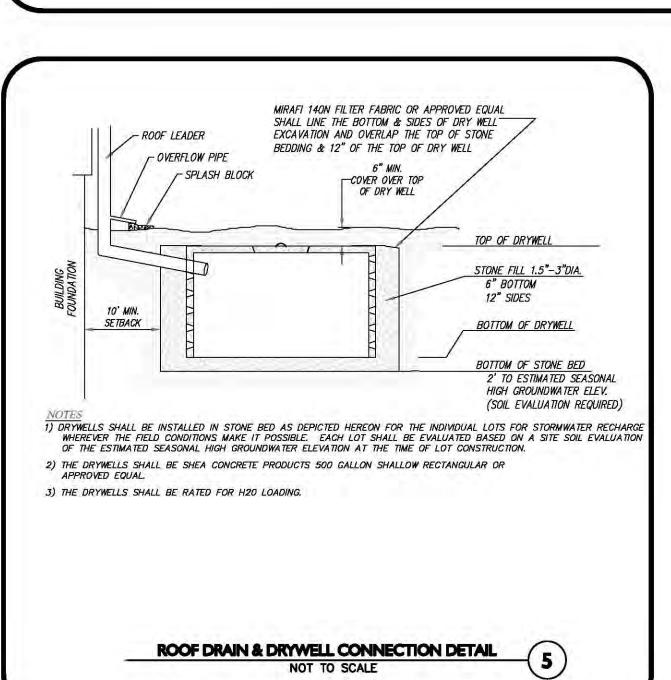

A SEWER MAIN AND A WATER/DRAIN MAIN:

SEWER MAIN SHALL BE AT LEAST 18 INCHES.

SEPARATION FROM THE POINT OF CROSSING.

POSITIONED AS SHOWN FOR UTILITY B.

FLOATATION DURING PLACEMENT OF CONCRETE.

SEWER WATER/DRAIN CROSSING

**NOT TO SCALE** 

THE CROSSING.

UTILITY A.

SHEET No. C-503

#### **Cherry Valley Sewer District**

Commissioners

Donald G. Manseau, Chairman

Victor M. Taylor, Commissioner

Micheal L. DellaCava, Commissioner

#### P. O. BOX 138 ROCHDALE, MASSACHUSETTS 01524

OFFICE: (508) 892-9616 FAX: (508) 892-4371

Jennifer M. Wood
Treasurer

Benjamin Morris Superintendent

March 9, 2021

RE:

Availability of Public Sewers:

651 Main St (vacant lots) Cherry Valley, MA 01611

Dear Mr. Grondin:

The intent of this letter is to verify that the above listed property is located in and serviced by the Cherry Valley Sewer District and is available for hook-up to the public sewer system.

Should you have any further questions, please feel free to contact the office at (508) 892-9616.

Respectfully,

Benjamin Morris Superintendent



#### LEICESTER WATER SUPPLY DISTRICT 124 PINE STREET - P.O. BOX 86 LEICESTER, MA 01524

TEL: 508 892-8484 FAX: 508-892-1812

www.lwsd.net

To whom it may concern:

Please be advised that there is adequate water supply for the proposed 35 duplex homes at 651 Main Street.

Connection fee: per duplex

WATER: \$7,000.00

Sincerely,

Joseph H. Wood- Superintendent Leicester Water Supply District