
SITE PLAN MODIFICATION GREENVILLE BAPTIST CHURCH

674 PLEASANT STREET LEICESTER, MA 01542

FEBRUARY 14, 2020

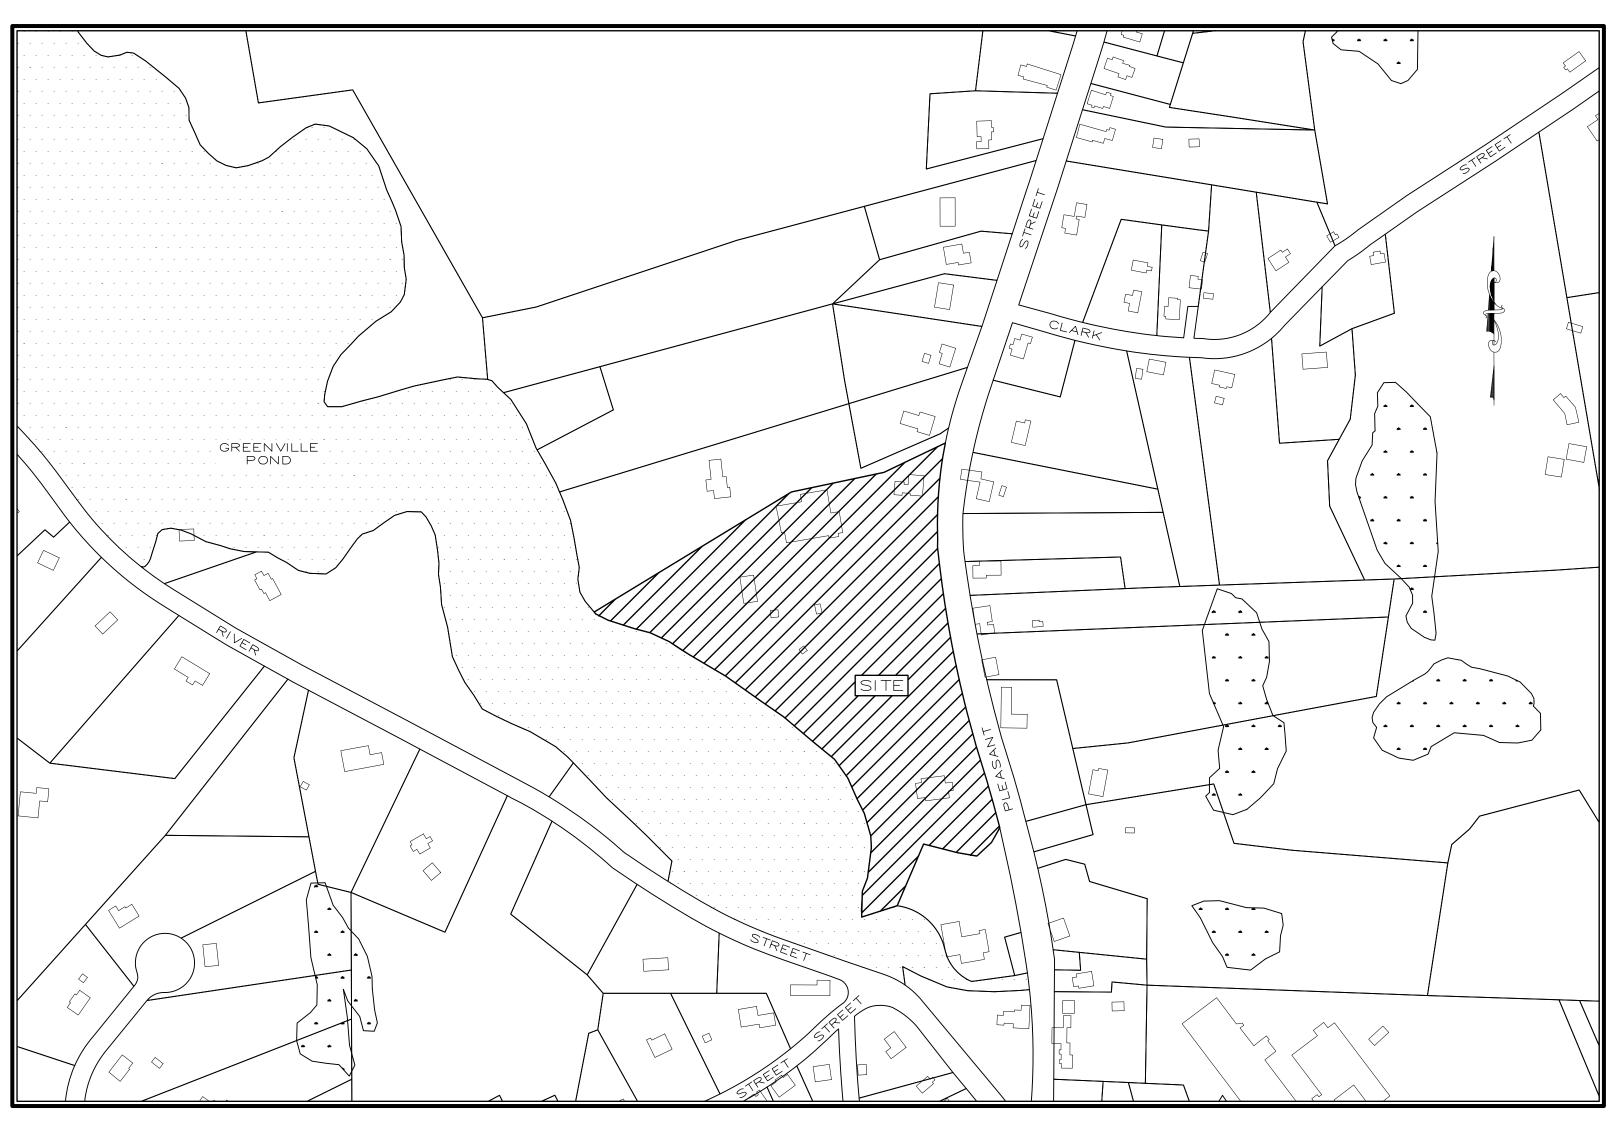

GENERAL SITE NOTES:

3. ALL UNDERGROUND UTILIIES ARE APPROXIMATE AND DERIVED FROM A PLANS DRAWN BY

5. A PORTION OF THE SITE DOES LIE WITHIN THE SPECIAL FLOOD HAZARD AREA AS REFERENCED ON NATIONAL FLOOD INSURANCE RATE MAP NO. 25027C0783E, FOR COMMUNITY NO. AND DATED JULY 4, 2011. NO PROPOSED WORK IS LOCATED WITHIN THE

4. WETLANDS FLAGGED BY SCOTT MORIRISON OF ECOTEC, INC. ON JUNE 25, 2002

DRAWING INDEX

SITE LOCUS

1" = 200'


TITLE SHEET EXISTING CONDITIONS PLAN SITE LAYOUT PLAN SEDIMENTATION AND EROSION CONTROL PLAN PHOTOMETRIC LIGHTING PLAN CONSTRUCTION DETAILS CONSTRUCTION DETAILS


LEICESTER	PLANNIN	IG BOARD
SITE PL	AN APP	ROVAL

TITLE SHEET

DRAWN BY: 2/14/2020 1" = 200' 151-2058-K PROJ. NO.

C-1

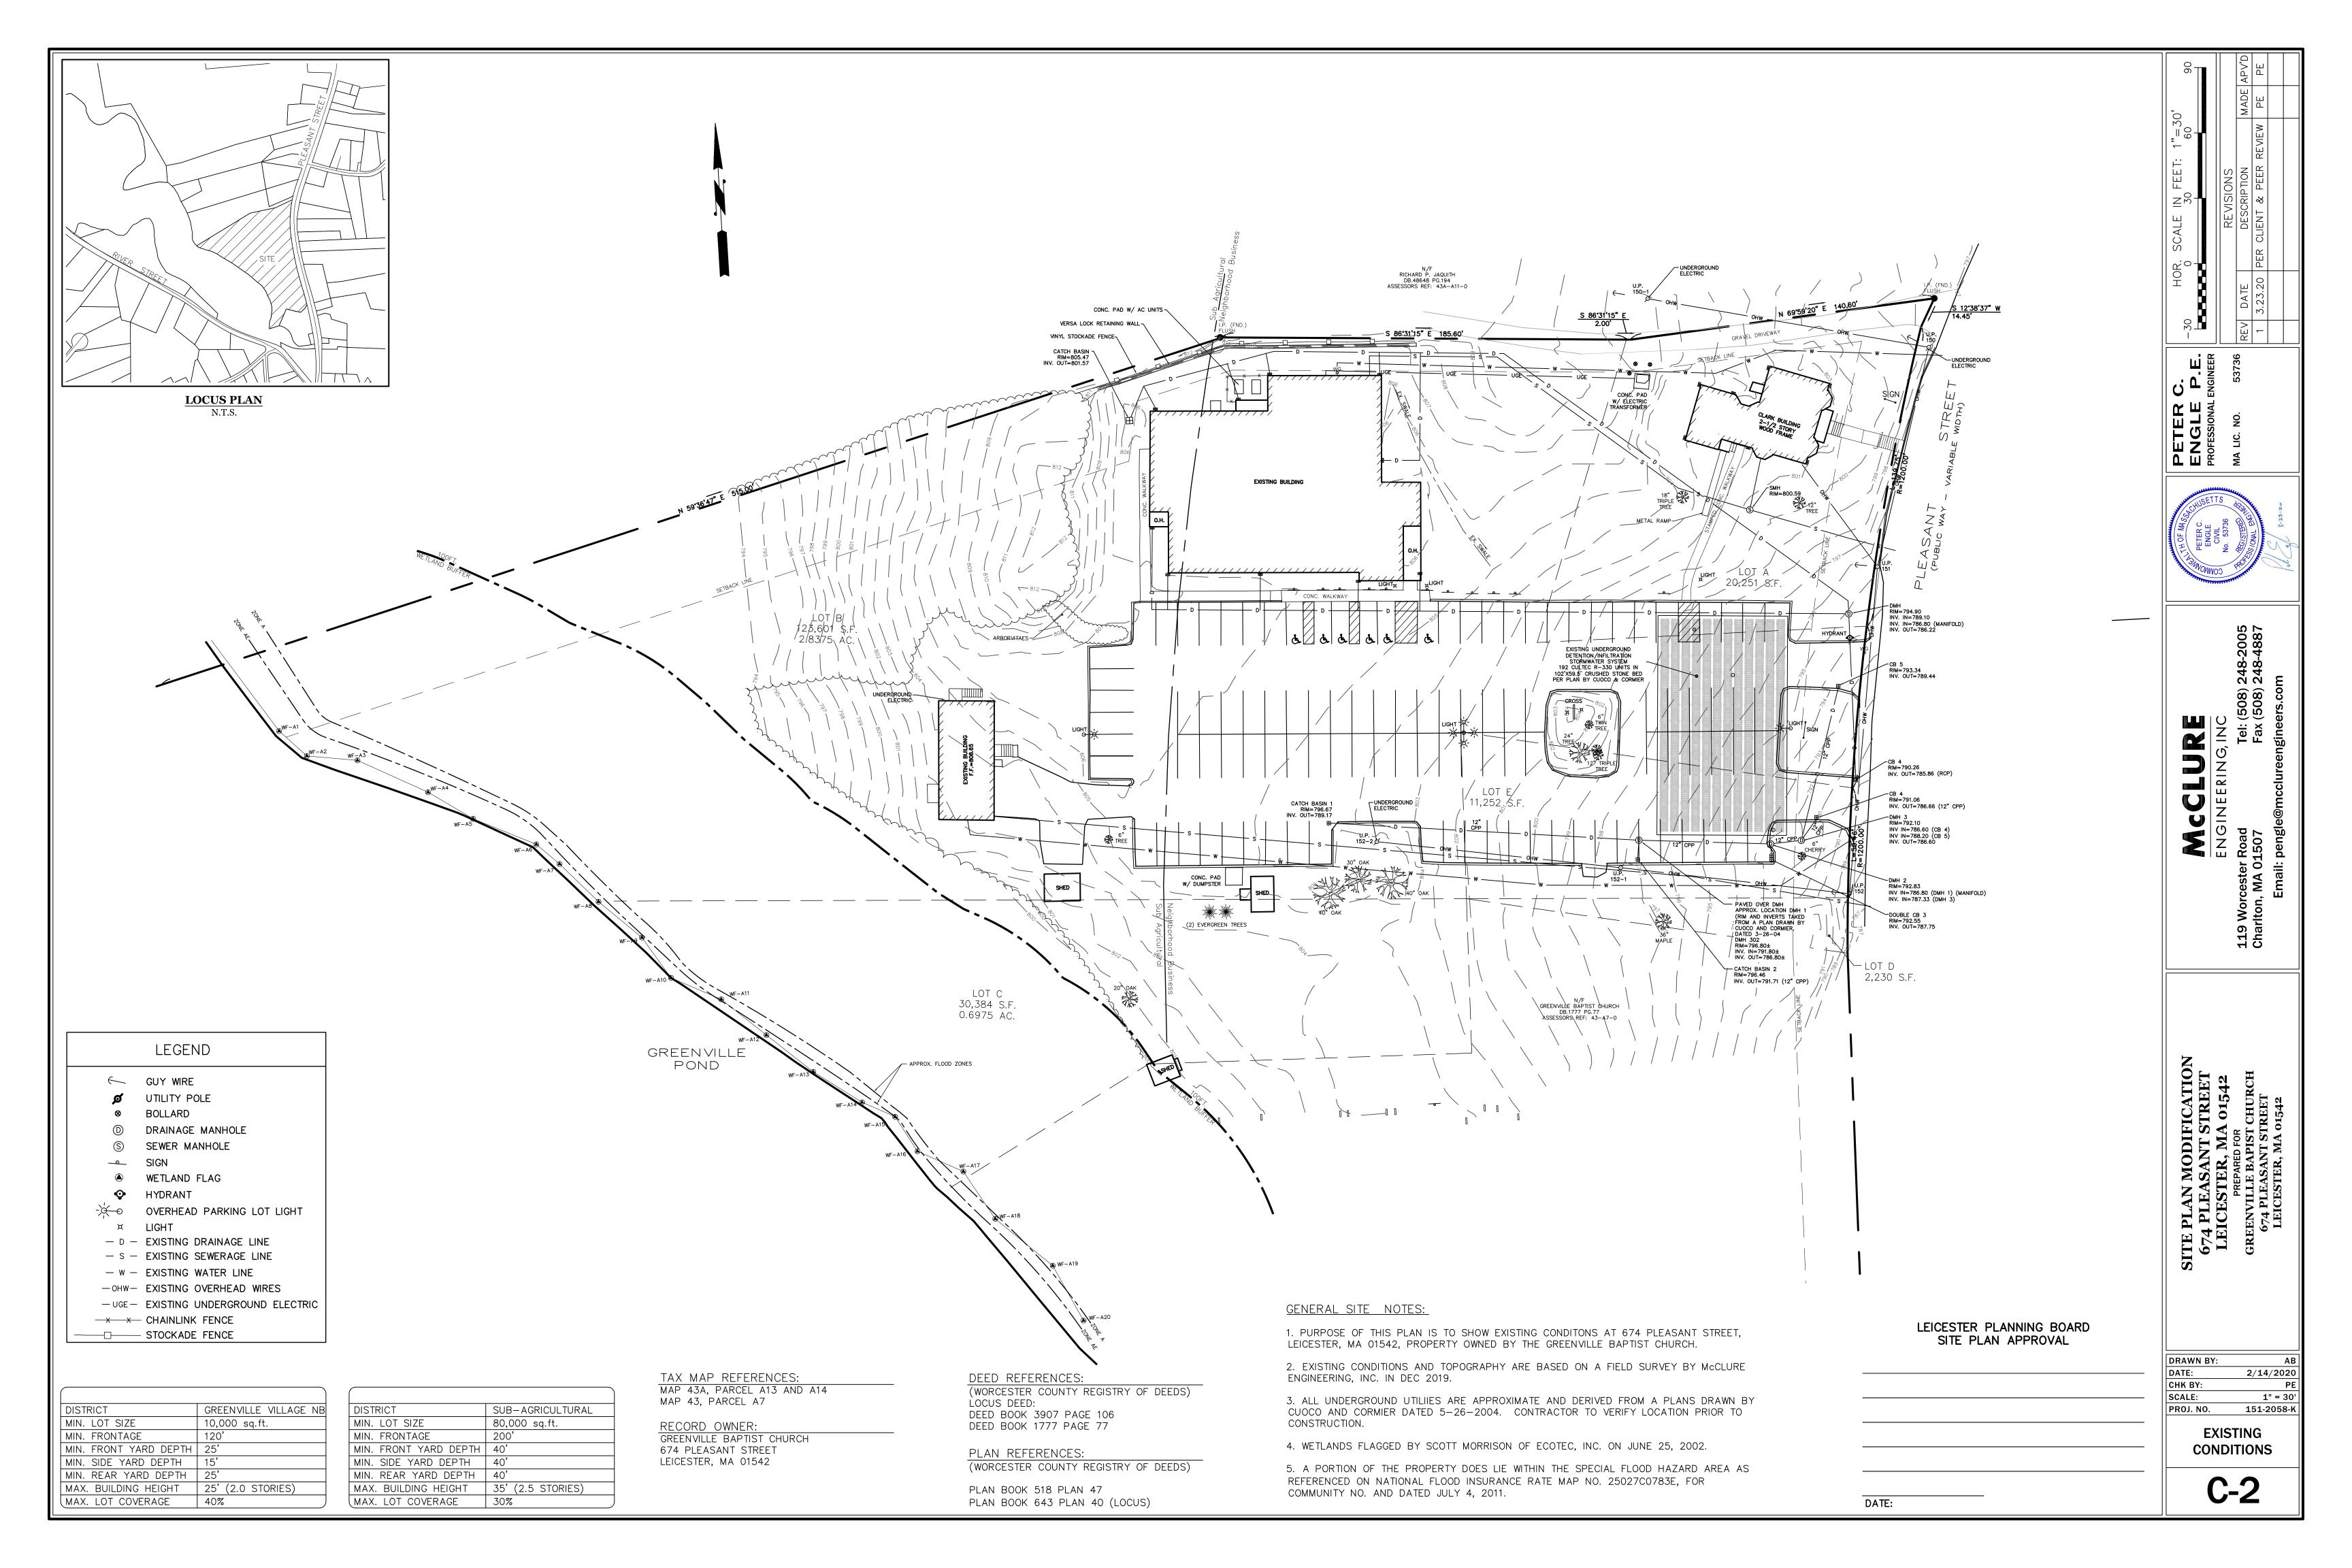

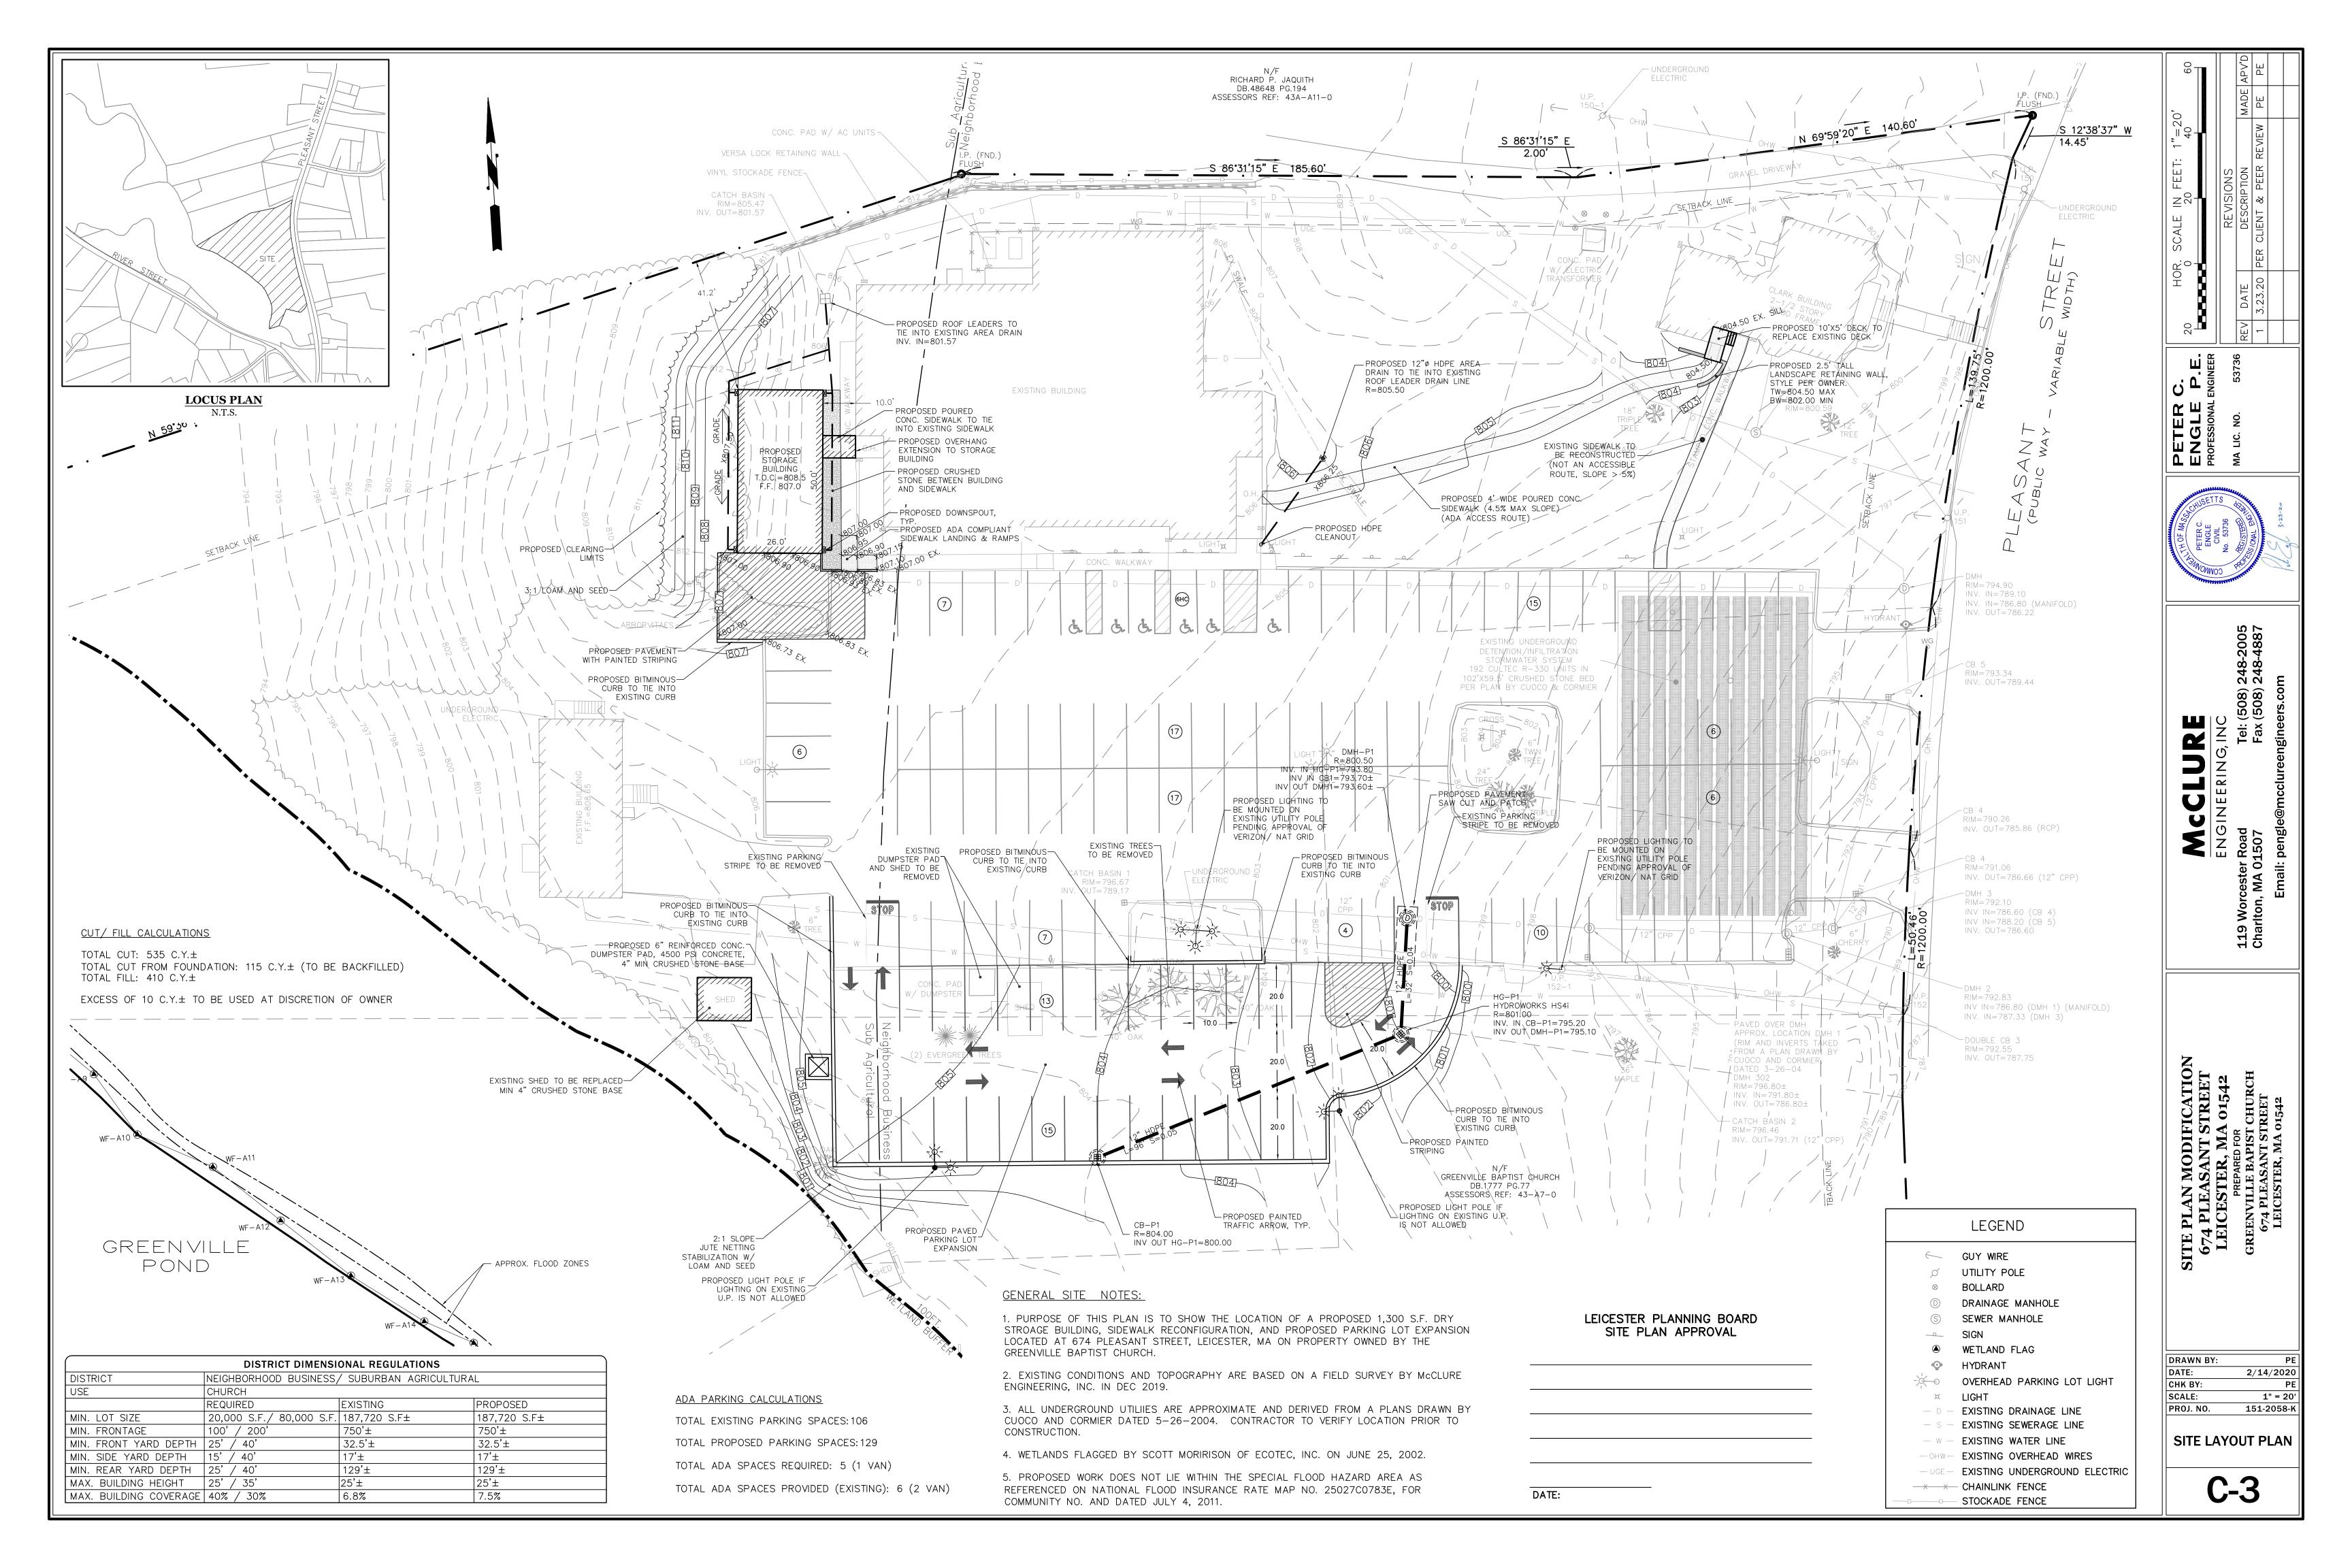

RESPONSIBILITIES OF OWNER/PERMITEE

THE OWNER/ PERMITTEE SHALL: A. PROVIDE THE CONTRACTOR WITH COPIES OF LAND-USE PERMITS THAT THE OWNER HAS ACQUIRED.

B. INFORM ALL PARTIES INVOLVED WITH THE PROPOSED SITE WORK OF THIS PLAN'S OBJECTIVES AND REQUIREMENTS.

RESPONSIBILITIES OF CONTRACTOR THE CONTRACTOR IS RESPONSIBLE FOR PREVENTING EROSION OF THE SITE AND FOR PROTECTING ADJACENT PROPERTIES, STORM SEWERS AND WATERWAYS FROM SEDIMENTATION.

THE CONTRACTOR SHALL:

A. INSTALL, MONITOR, AND MAINTAIN ALL OF THE SOIL EROSION AND SEDIMENT CONTROL MEASURES AS SHOWN ON

B. COMPLY WITH ALL PERMIT REQUIREMENTS.

PRE-CONSTRUCTION CONFERENCE THE PERMITEE, OWNER-OF-RECORD, CONTRACTOR, ENGINEER, AND THE TOWN SHALL HOLD A "PRE-CONSTRUCTION"

CONFERENCE REVIEW THE PROPOSED SOIL EROSION AND SEDIMENT CONTROL MEASURES.

GENERAL CONTROLS I. CLEANING OF STORMWATER STRUCTURES:

CLEAN ALL STORMWATER STRUCTURES INCLUDING, BUT NOT LIMITED TO, PIPES, SWALES, SUBSURFACE RETENTION BASINS, SEDIMENT TRAPS, AND RIPRAP APRONS OF SEDIMENT UPON COMPLETION OF THE PROJECT.

PLACE CLEAN WASHED STONE AT THE SITE ENTRANCES TO THE LENGTH, WIDTH AND DEPTH INDICATED ON THE PLANS AND DETAILS TO HELP REMOVE MUD AND/OR CLODS OF SOIL FROM CONSTRUCTION VEHICLES EXITING FROM THE SITE. ADD ADDITIONAL STONE AS NECESSARY TO MAINTAIN ADEQUATE SERVICEABILITY.

THE CONTRACTOR SHALL SWEEP PAVED ROADWAYS ADJACENT TO THE SITE ON A ROUTINE BASIS TO PREVENT TRACKING OF MUD ONTO PUBLIC ROADWAYS AND WASHING OF MUD INTO WATERWAYS. IF THE CONTRACTOR'S SCHEDULE FOR CLEANING THE PAVEMENT IS FOUND TO BE INADEQUATE BY THE OWNER, OWNER'S REPRESENTATIVE,

OR TOWN, THE CONTRACTOR SHALL INCREASE THE FREQUENCY AT NO ADDITIONAL COST TO THE OWNER.

THE CONTRACTOR SHALL PROVIDE AN ADEQUATE NUMBER OF COVERED WASTE CONTAINERS TO ENSURE THAT NO LITTER, DEBRIS, BUILDING MATERIALS, OR SIMILAR MATERIALS ARE DISCHARGED TO WETLANDS OR WATERCOURSES. THE CONTRACTOR SHALL INSTRUCT SUBCONTRACTORS TO USE THE CONTAINERS FOR WASTE MATERIAL. THE CONTAINERS SHALL BE PROMPTLY EMPTIED WHEN FULL.

DESCRIPTION AND MAINTENANCE OF EROSION CONTROL MEASURES

TEMPORARY STABILIZATION MEASURES

STRAW WATTLE TUBES:

INSTALL STRAW WATTLES AT VARIOUS LOCATIONS AS SHOWN ON THE PLANS AND DETAILS. EMBED THE STRAW WATTLES INTO THE GROUND AND FIRMLY ANCHOR IT AS SHOWN IN THE DETAILS. REMOVE SEDIMENT ONCE LEVELS HAVE REACHED 1/4 OF THE EFFECTIVE HEIGHT. REPAIR AND/OR REPLACE STRAW WATTLES IMMEDIATELY IF DAMAGED OR DETERIORATED.

INLET PROTECTION: INSTALL INLET PROTECTION/ SILT SACKS AT VARIOUS EXISTING CATCH BASIN LOCATIONS AS SHOWN ON THE PLAN

AND DETAILS.

STOCKPILING OR STORAGE OF EXCAVATED MATERIALS: COMPLETELY SURROUND TEMPORARY MATERIAL STOCKPILES WITH STRAW WATTLES TO PREVENT

TRANSPORTATION OF SEDIMENT.

TAKE PRECAUTIONS TO PREVENT DUST FROM BECOMING A NUISANCE TO ABUTTING PROPERTY OWNERS. BROOM OFF PAVEMENT AREAS ADJOINING THE EXCAVATION ON A DAILY BASIS. COVER AND/OR KEEP MOIST ALL EARTH STOCKPILES AT ALL TIMES. USE CALCIUM CHLORIDE TO CONTROL DUST OVER CERTAIN AREAS OF THE SITE AS NEEDED AND/OR AS DIRECTED BY THE ENGINEER. CALCIUM CHLORIDE SHALL CONFORM TO ASTM D-98. TYPE I. THE CONTRACTOR SHALL MAINTAIN AND INSPECT, ON A DAILY BASIS, THE ADEQUACY OF DUST CONTROL MEASURES AND CORRECT ANY DEFICIENCIES IMMEDIATELY.

PERMANENT STABILIZATION MEASURES

DISTURBED PORTIONS OF THE SITE WHERE CONSTRUCTION ACTIVITIES PERMANENTLY CEASE SHALL BE STABILIZED WITH PERMANENT SEED NO LATER THAN 14 DAYS AFTER THE LAST CONSTRUCTION ACTIVITY.

THE CONTRACTOR SHALL BE RESPONSIBLE FOR ALL LANDSCAPED AREAS. IF TOPSOIL, SEE, AND/OR MULCH IS WASHED AWAY BY RAINFALL, THE CONTRACTOR SHALL RESTORE THE AREA.

1. AT NO TIME SHALL EXCAVATION "DEWATERING BE DIRECTLY DISCHARGED TO: CATCH BASIN, DRAIN PIPE WETLAND, STREAM, OR FLOOD PLAIN AREA.

- 2. TRENCH & EXCAVATION DE-WATERING WASTEWATER SHALL BE DISCHARGED THROUGH AN "ULTRA PIPESOCK" OR EQUIVALENT SEDIMENT/OIL FILTER TRAP WITH 12" DEPTH GRAVEL FILTER BERM.
- 3. DE-WATERING DISCHARGES SHALL BE DIRECTED TO ON-SITE SEDIMENT CONTROL SYSTEMS AND/OR DRAINAGE SWALES.

GENERAL CONDITIONS

. IF EROSION CONTROL MEASURES ARE DAMAGED BY CONSTRUCTION VEHICLES, ACTS OF VANDALISM, OR SEVERE WEATHER CONDITIONS, THE CONTRACTOR SHALL IMMEDIATELY REMOVE SEDIMENT IN THE VICINITY OF THE EROSION CONTROL MEASURES AND REPAIR THESE MEASURES TO A FUNCTIONAL CONDITION.

2. IF, DURING OR AFTER CONSTRUCTION, IT BECOMES APPARENT THAT EXISTING EROSION CONTROL MEASURES ARE INCAPABLE OF CONTROLLING EROSION, THE ENGINEER OR THE TOWN MAY REQUIRE ADDITIONAL CONTROL MEASURES, INCLUDING BUT NOT LIMITED TO; ADDITIONAL STRAW WATTLES, HAYBALES, SILT FENCE, SEDIMENT BASINS, MECHANICALLY ANCHORED MULCH, OR ENHANCED DEWATERING FILTRATION.

3. NO CONSTRUCTION SHALL PROCEED UNTIL A WRITTEN PROPOSAL OF METHODS TO PREVENT CONSTRUCTION DEBRIS. PAINT, OR OTHER SUCH CONTAMINATED MATERIALS FROM ENTERING A STORM SEWER, THE WETLAND, OR WATERCOURSE HAS BEEN SUBMITTED BY THE CONTRACTOR TO THE OWNER. APPROVED BY THE OWNER AND SUCH METHODS HAVE BEEN IMPLEMENTED AS THE OWNER DIRECTS. THESE MATERIALS SHALL BE COLLECTED AND DISPOSED OF IN AN ENVIRONMENTALLY SAFE MANNER IN ACCORDANCE WITH ALL APPLICABLE FEDERAL AND STATE LAWS AND REGULATIONS. THE OWNER MAY ORDER THE CONTRACTOR TO CEASE SUCH ACTIVITY TEMPORARILY IF, IN THE JUDGMENT OF THE OWNER, WIND OR STORM CONDITIONS THREATEN TO CAUSE THE DEPOSIT OF SUCH MATERIAL IN A WATERWAY.

4. ALL TEMPORARY FILL SHALL BE STABILIZED DURING USE TO PREVENT EROSION AND SHALL BE SUITABLY CONTAINED TO PREVENT SEDIMENT OF OTHER PARTICULATE MATTER FROM REENTERING A WETLAND OR WATERCOURSE. ALL AREAS AFFECTED BY TEMPORARY FILLS MUST BE RESTORED TO THEIR ORIGINAL CONTOURS OR AS DIRECTED BY THE OWNER, AND REVEGETATED. THE AREA EXTENT OF TEMPORARY FILL OR EXCAVATION SHALL BE CONFINED TO THAT AREA NECESSARY TO PERFORM THE WORK, AS APPROVED BY THE

5. DUMPING OF OIL, CHEMICALS OR OTHER DELETERIOUS MATERIALS ON THE GROUND IS FORBIDDEN. THE CONTRACTOR SHALL PROVIDE A MEANS OF CATCHING, RETAINING, AND PROPERLY DISPOSING OF DRAINED OIL, REMOVED OIL FILTERS, OR OTHER DELETERIOUS MATERIAL. ALL SPILLS OF SUCH MATERIALS SHALL BE REPORTED IMMEDIATELY BY THE CONTRACTOR TO APPROPRIATE TOWN AND STATE AGENCIES.

6. INSPECTIONS: EROSION CONTROL SHOULD BE INSPECTED DAILY OR AFTER A LEGITIMATE STORM EVENT.

TOTAL LAND DISTURBANCE: 26,500 S.F.±


GENERAL SITE NOTES:

. EXISTING CONDITIONS AND TOPOGRAPHY ARE BASED ON A FIELD SURVEY BY McCLURE ENGINEERING, INC. IN DEC 2019.

2. ALL UNDERGROUND UTILIIES ARE APPROXIMATE AND DERIVED FROM A PLANS DRAWN BY CUORCO AND CORMIER DATED 5-26-2004. CONTRACTOR TO VERIFY LOCATION PRIOR TO CONSTRUCTION.

3. WETLANDS FLAGGED BY SCOTT MORIRISON OF ECOTEC, INC. ON JUNE 25, 2002

3. PROPERTY DOES, WORK DOES NOT LIE WITHIN THE SPECIAL FLOOD HAZARD AREA AS REFERENCED ON NATIONAL FLOOD INSURANCE RATE MAP NO. 25027C0783E, FOR COMMUNITY NO. AND DATED JULY 4, 2011.

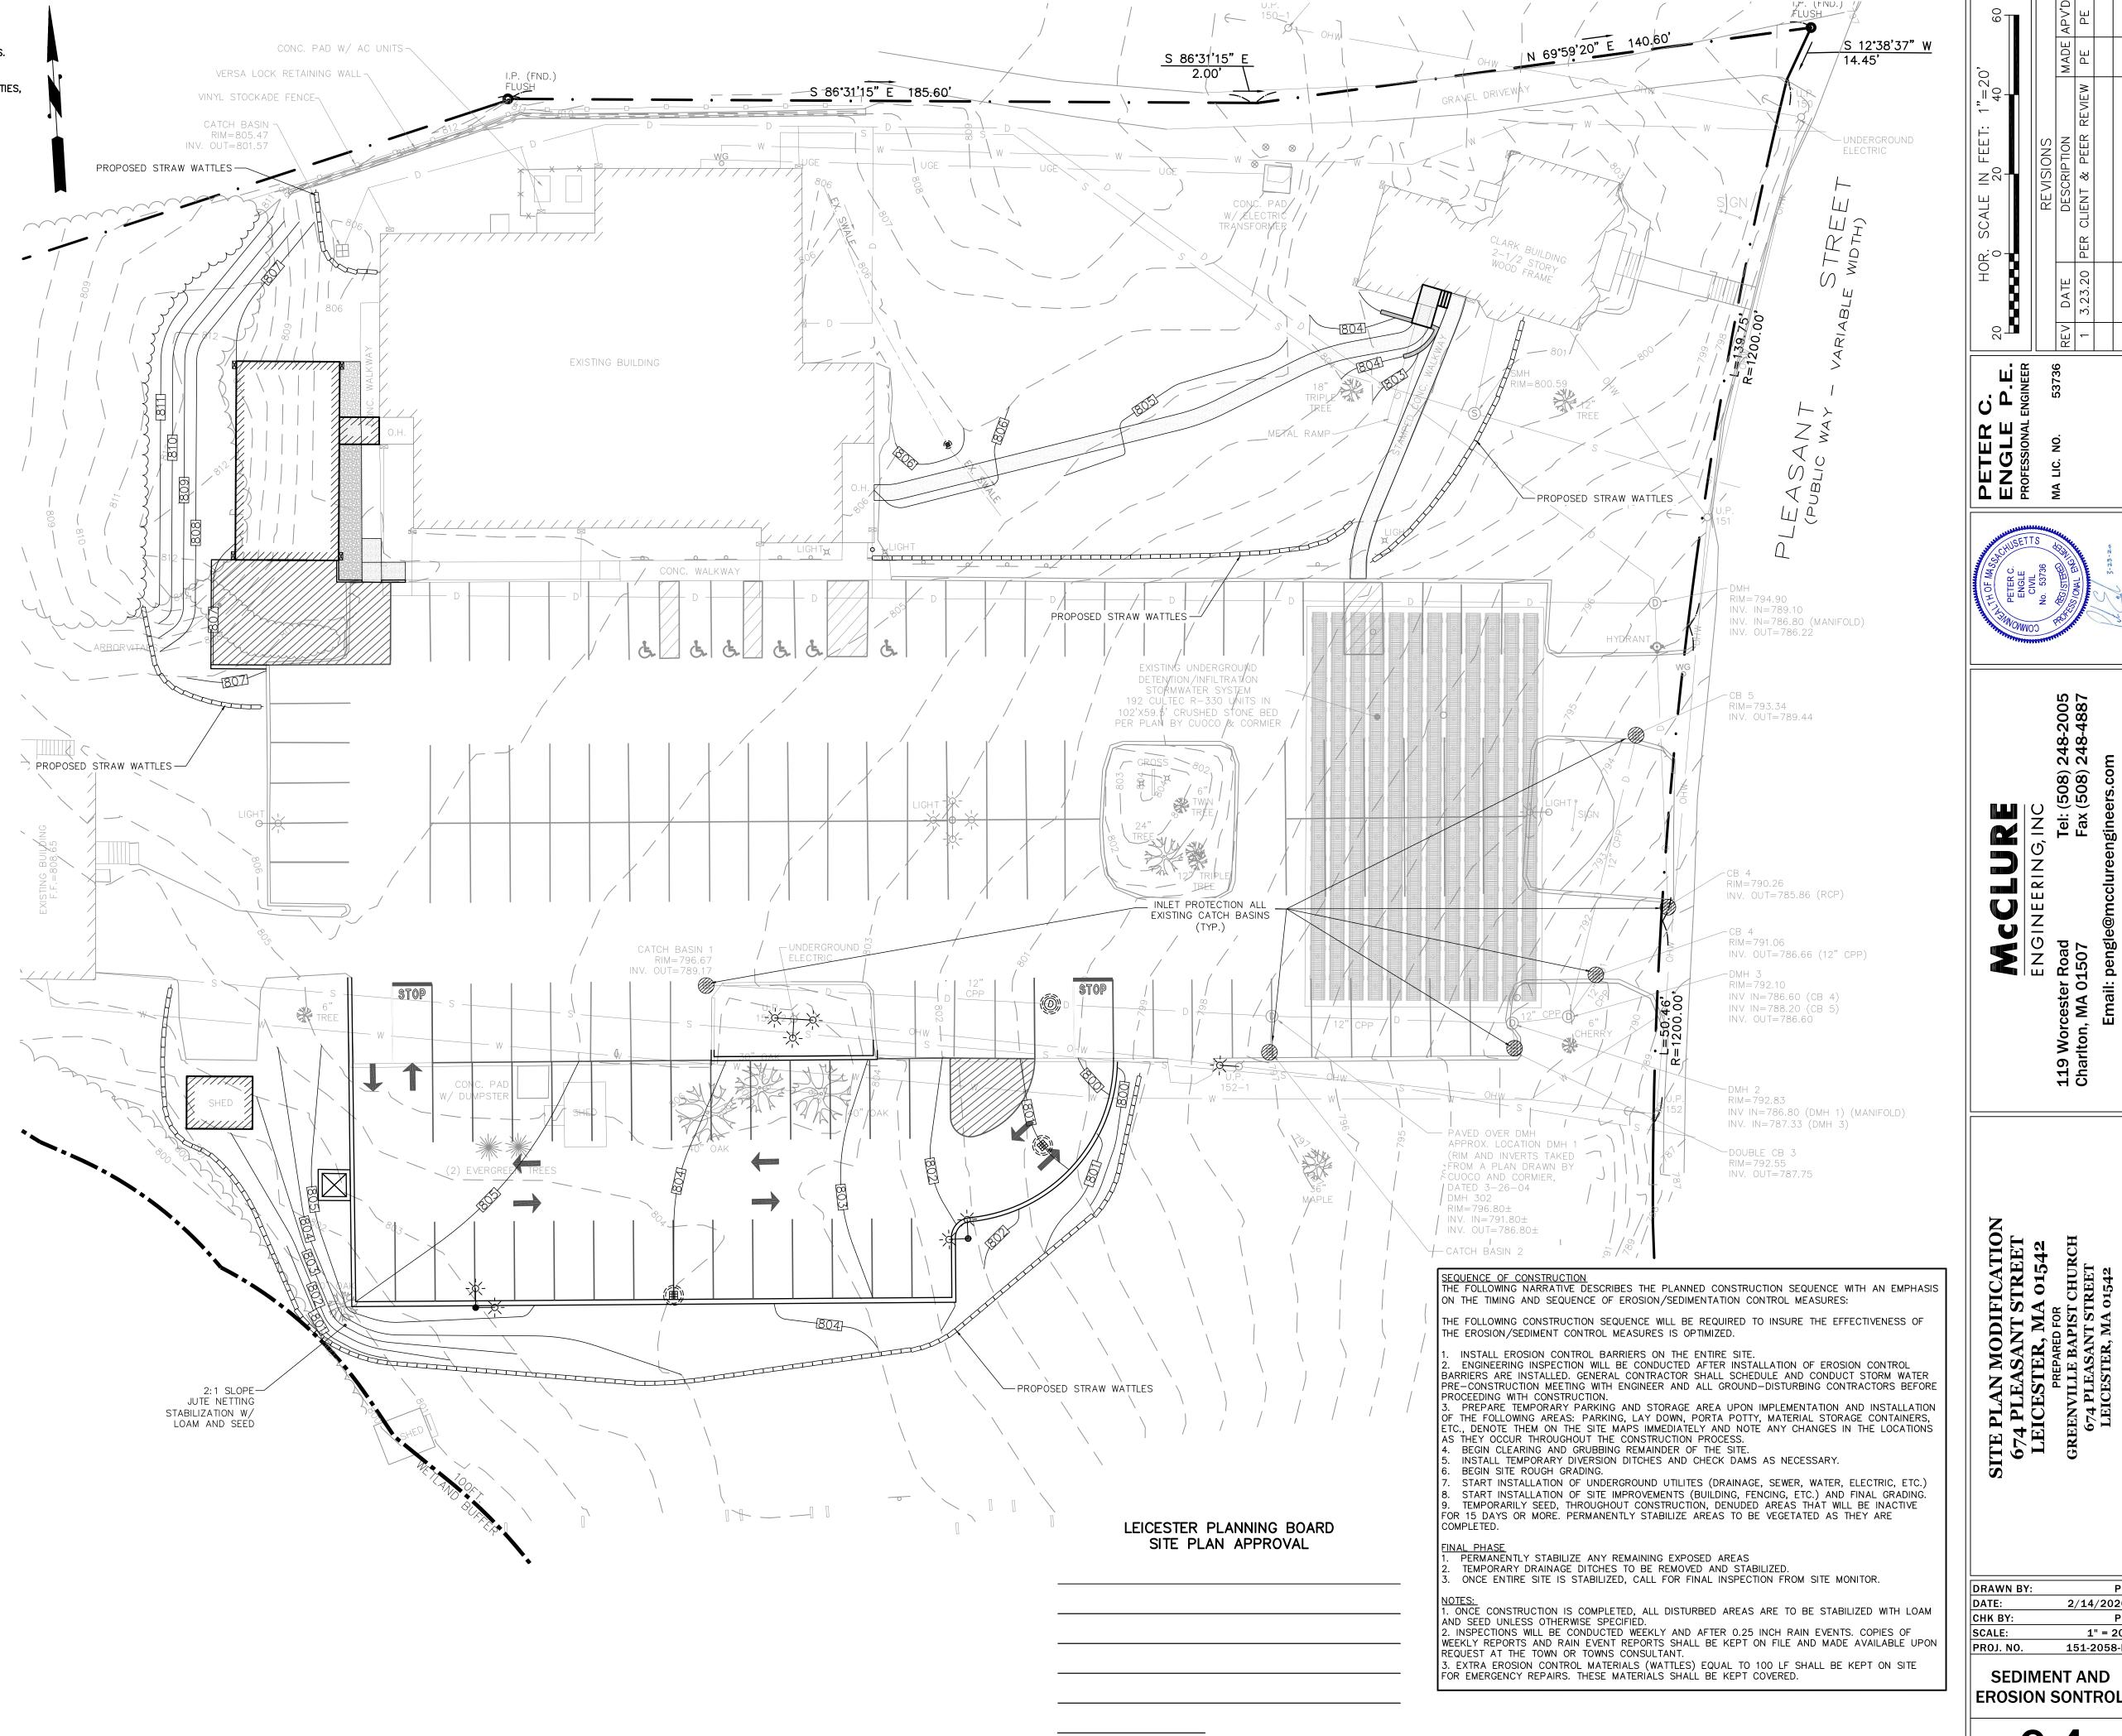

24 24


ASANT STREET
FER, MA 01542
REPARED FOR
LE BAPIST CHURCH
SASANT STREET

2/14/2020

151-2058-K

SEDIMENT AND

1" = 20'

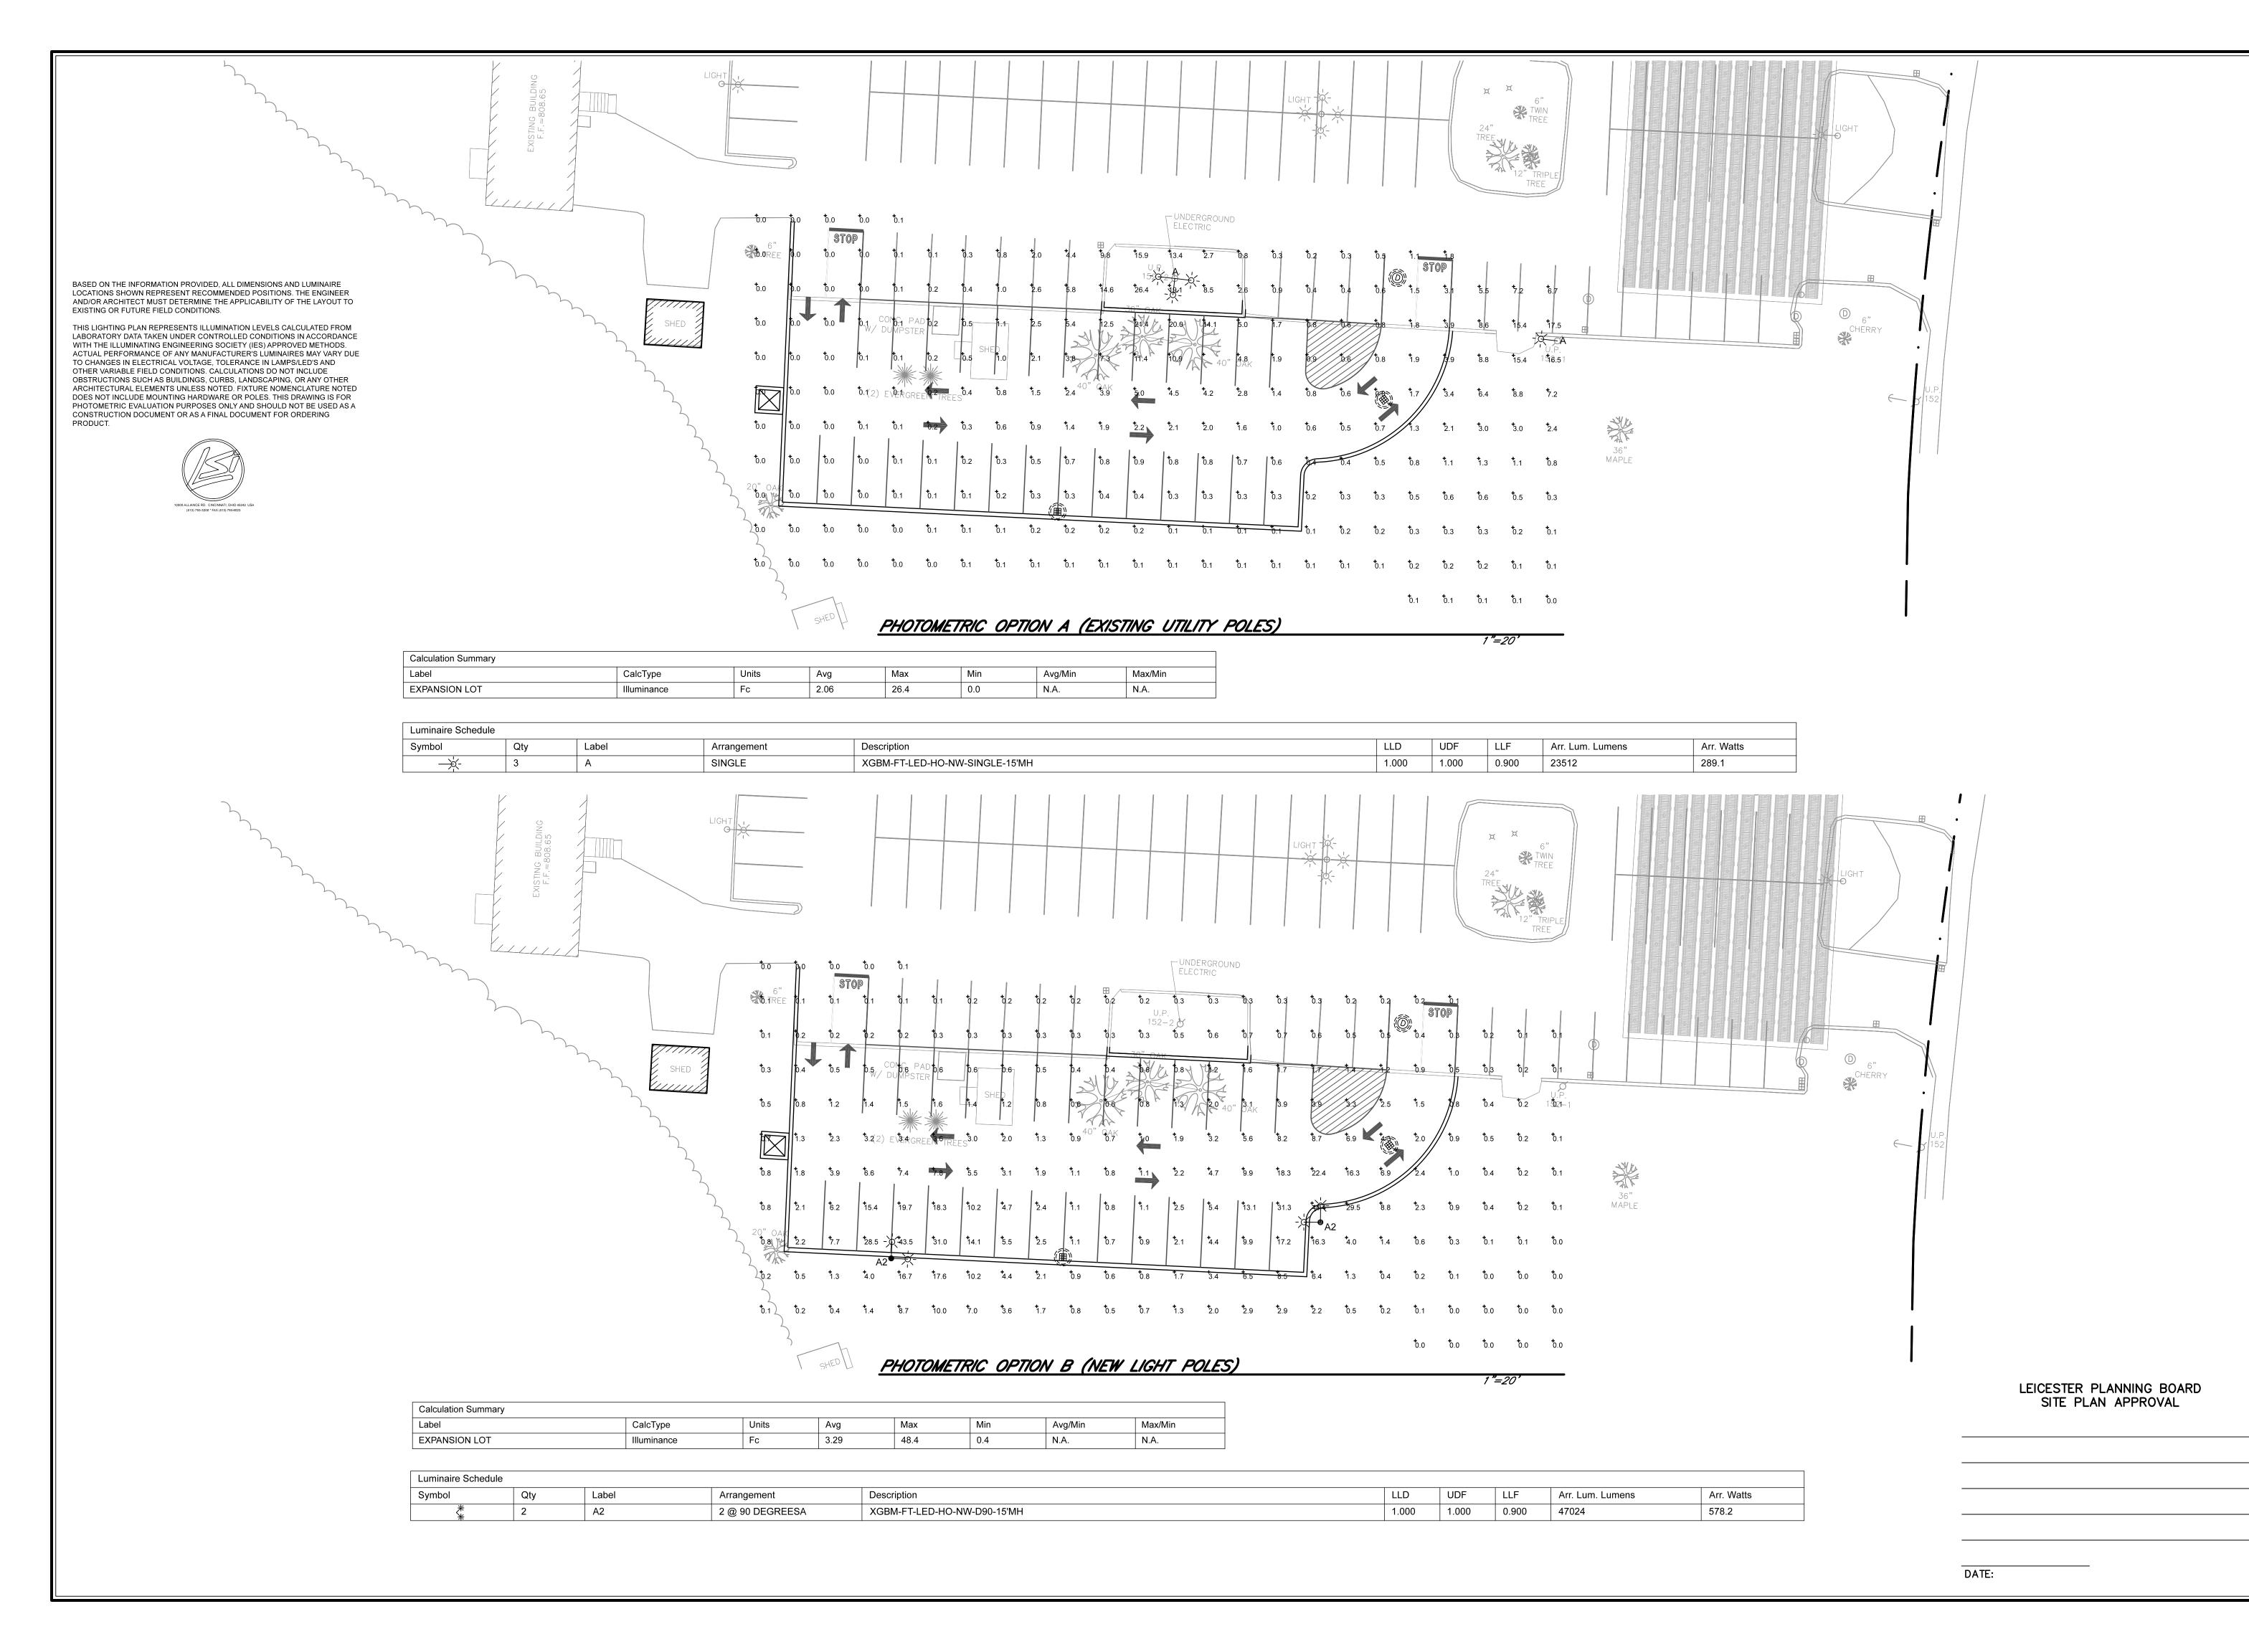



Tel: (508) 248-2005 Fax (508) 248-4887

SITE PLAN MODIFICATION 674 PLEASANT STREET LEICESTER, MA 01542

DRAWN BY: 2/14/2020 1" = 20 PROJ. NO. 151-2058-K


> **PHOTOMETRIC** LIGHTING PLAN

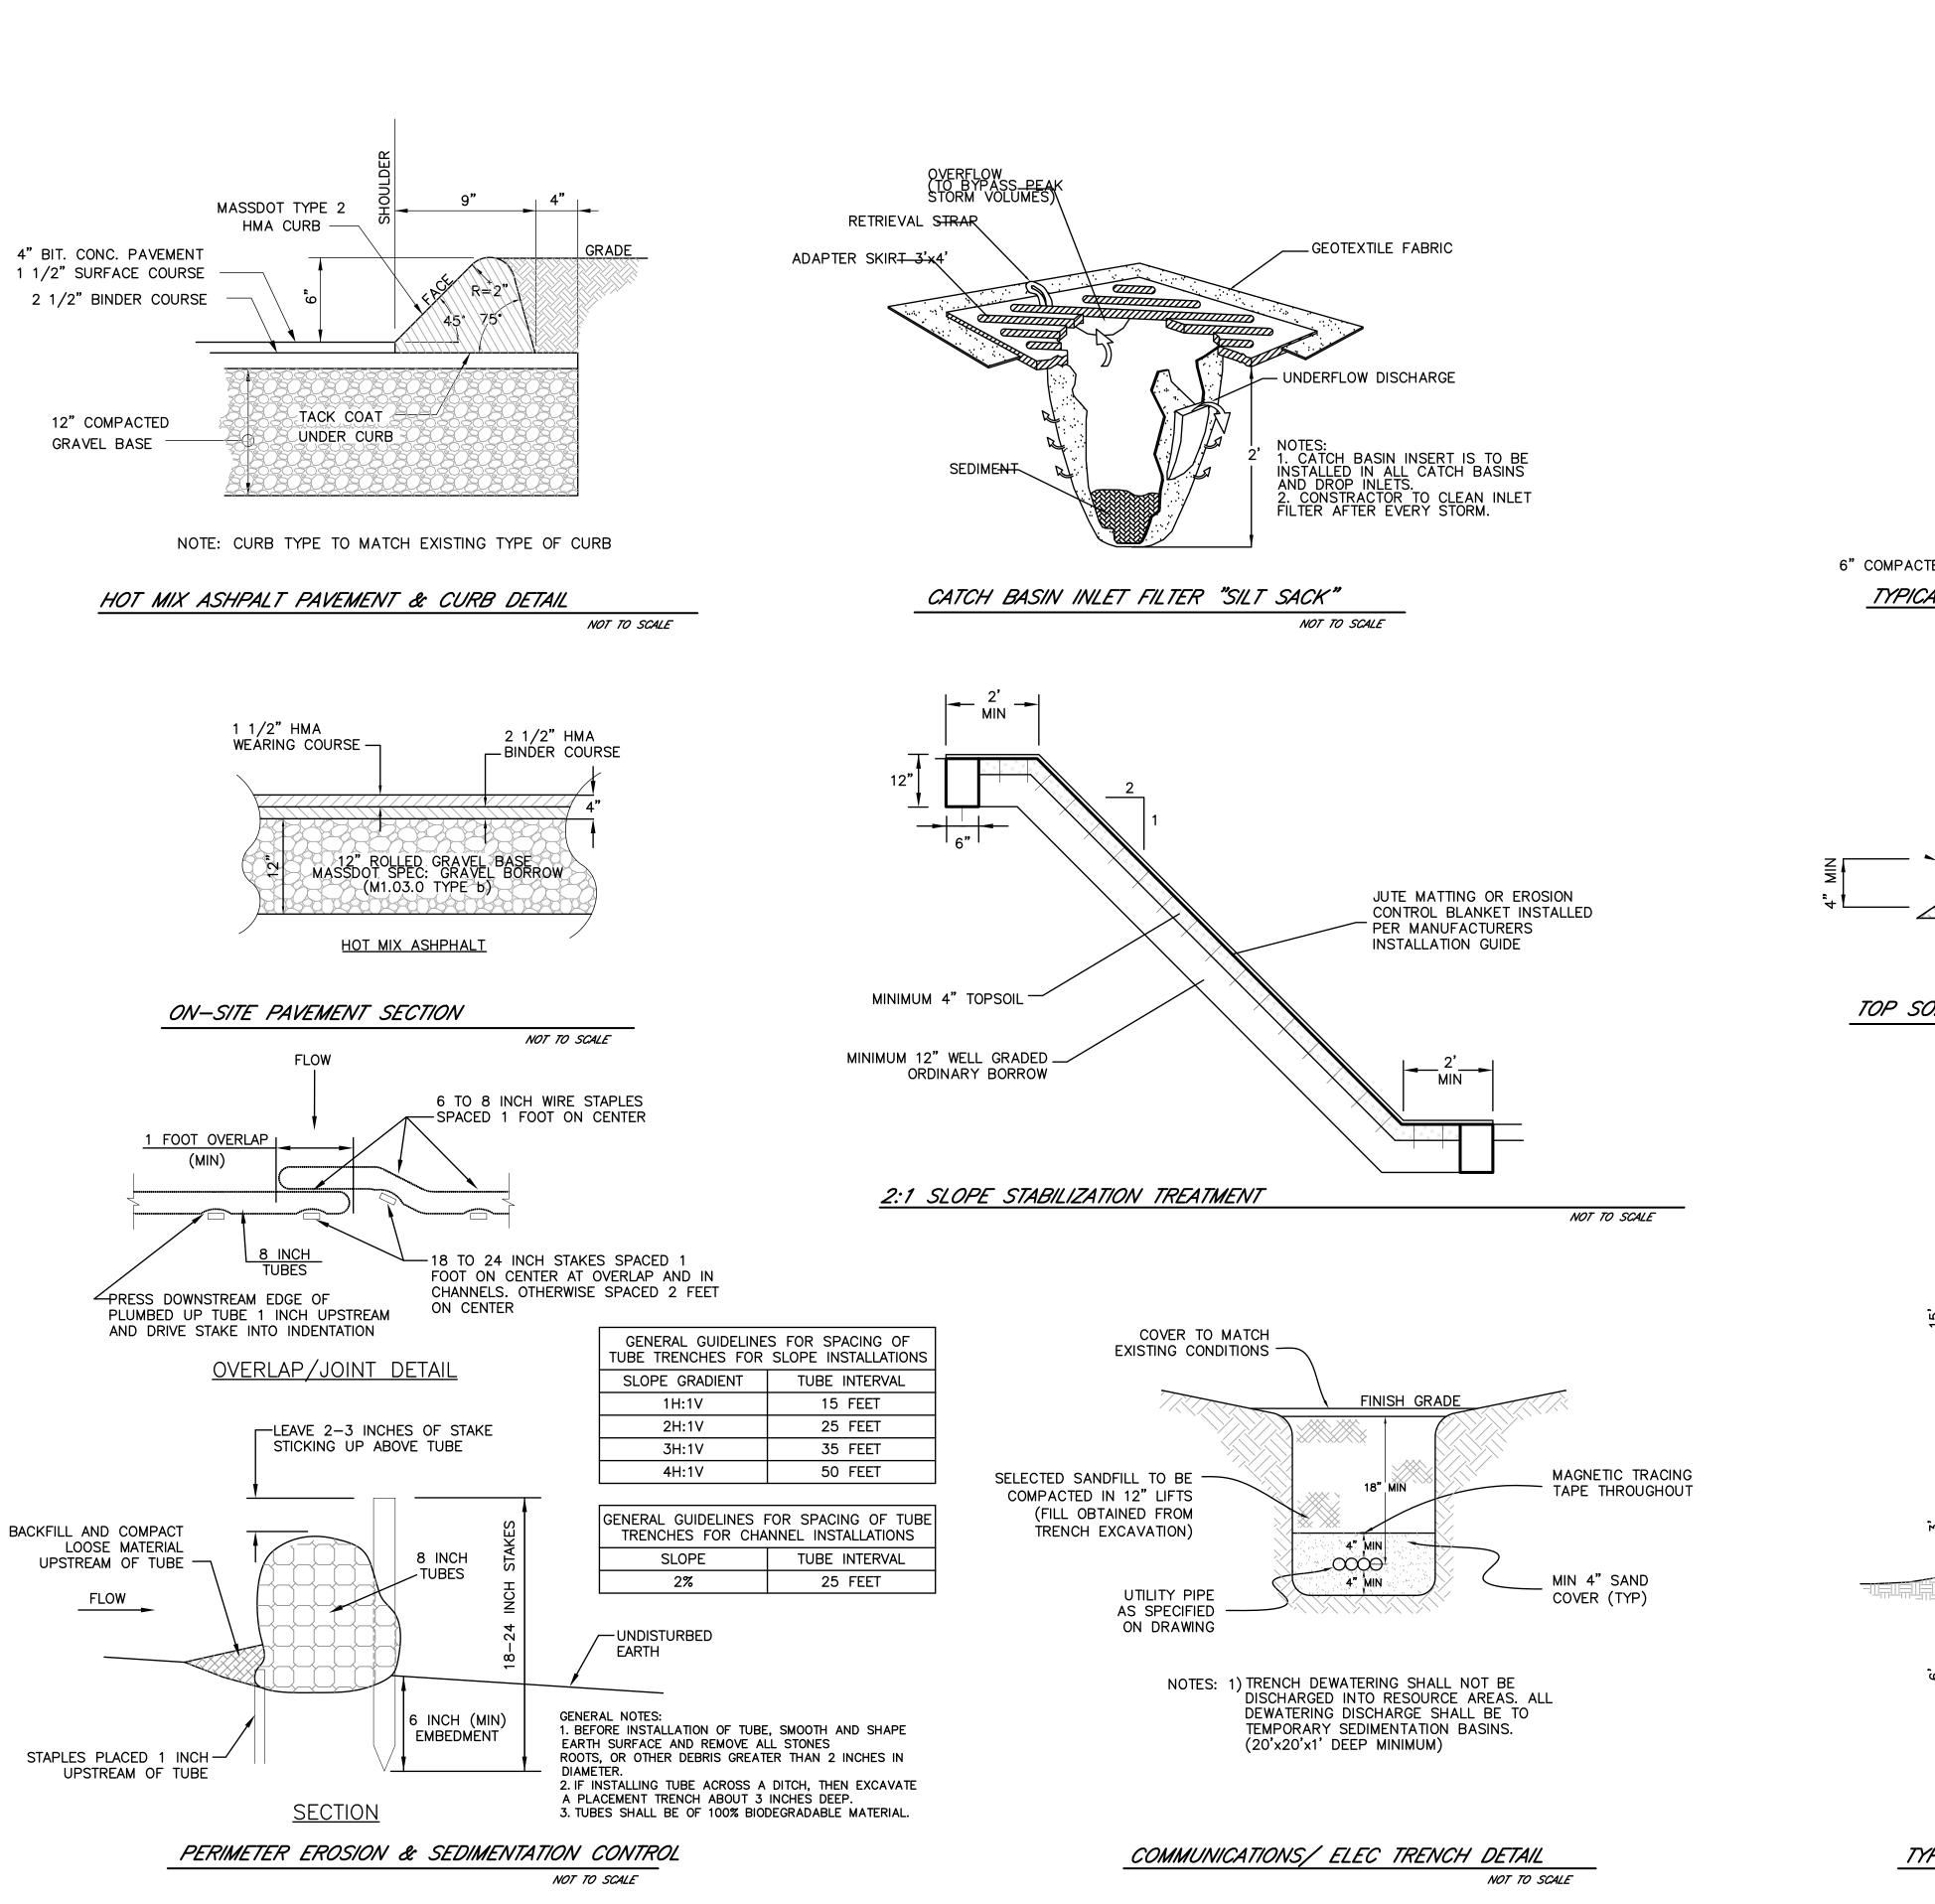

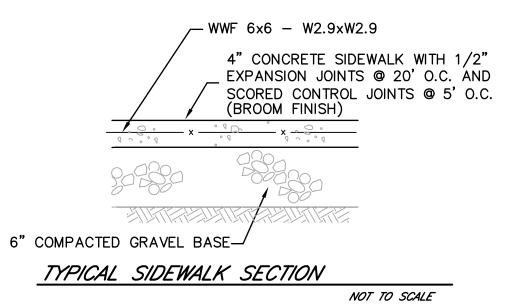

SEED & LIGHT MULCHING OF CLEAN, WEED-FREE STRAW TOPSOIL TO BE REMOVED OF DEBRI AND OBJECTIONABLE WEED AND STONES. TOPSOIL SHALL BE FRIABLE AND LOAMY AND CONTAIN NO TOXIC SUBSTANCE HARMFUL TO PLANT GROWTH UNDISTURBED EARTH

TOP SOIL & SEEDING DETAIL NOT TO SCALE

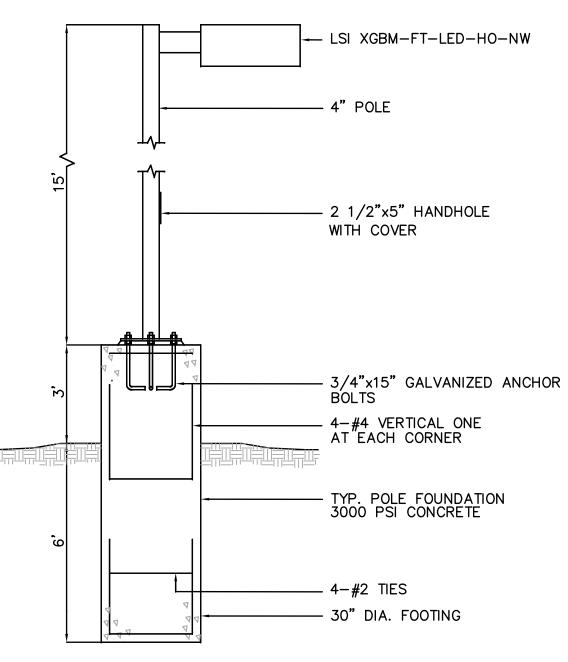

TYPICAL LIGHT POLE FOOTING DETAIL NOT TO SCALE

LEICESTER PLANNING BOARD

SITE PLAN APPROVAL

DATE:

DETAIL SHEET

DRAWN BY:

CHK BY:

PROJ. NO.

2/14/2020


AS NOTE


151-2058-K

C-6

(508) 248-2005 (508) 248-4887

SITE PLAN MODIFICATION
674 PLEASANT STREET
LEICESTER, MA 01542
PREPARED FOR
GREENVILLE BAPIST CHURCH
674 PLEASANT STREET
LEICESTER, MA 01542

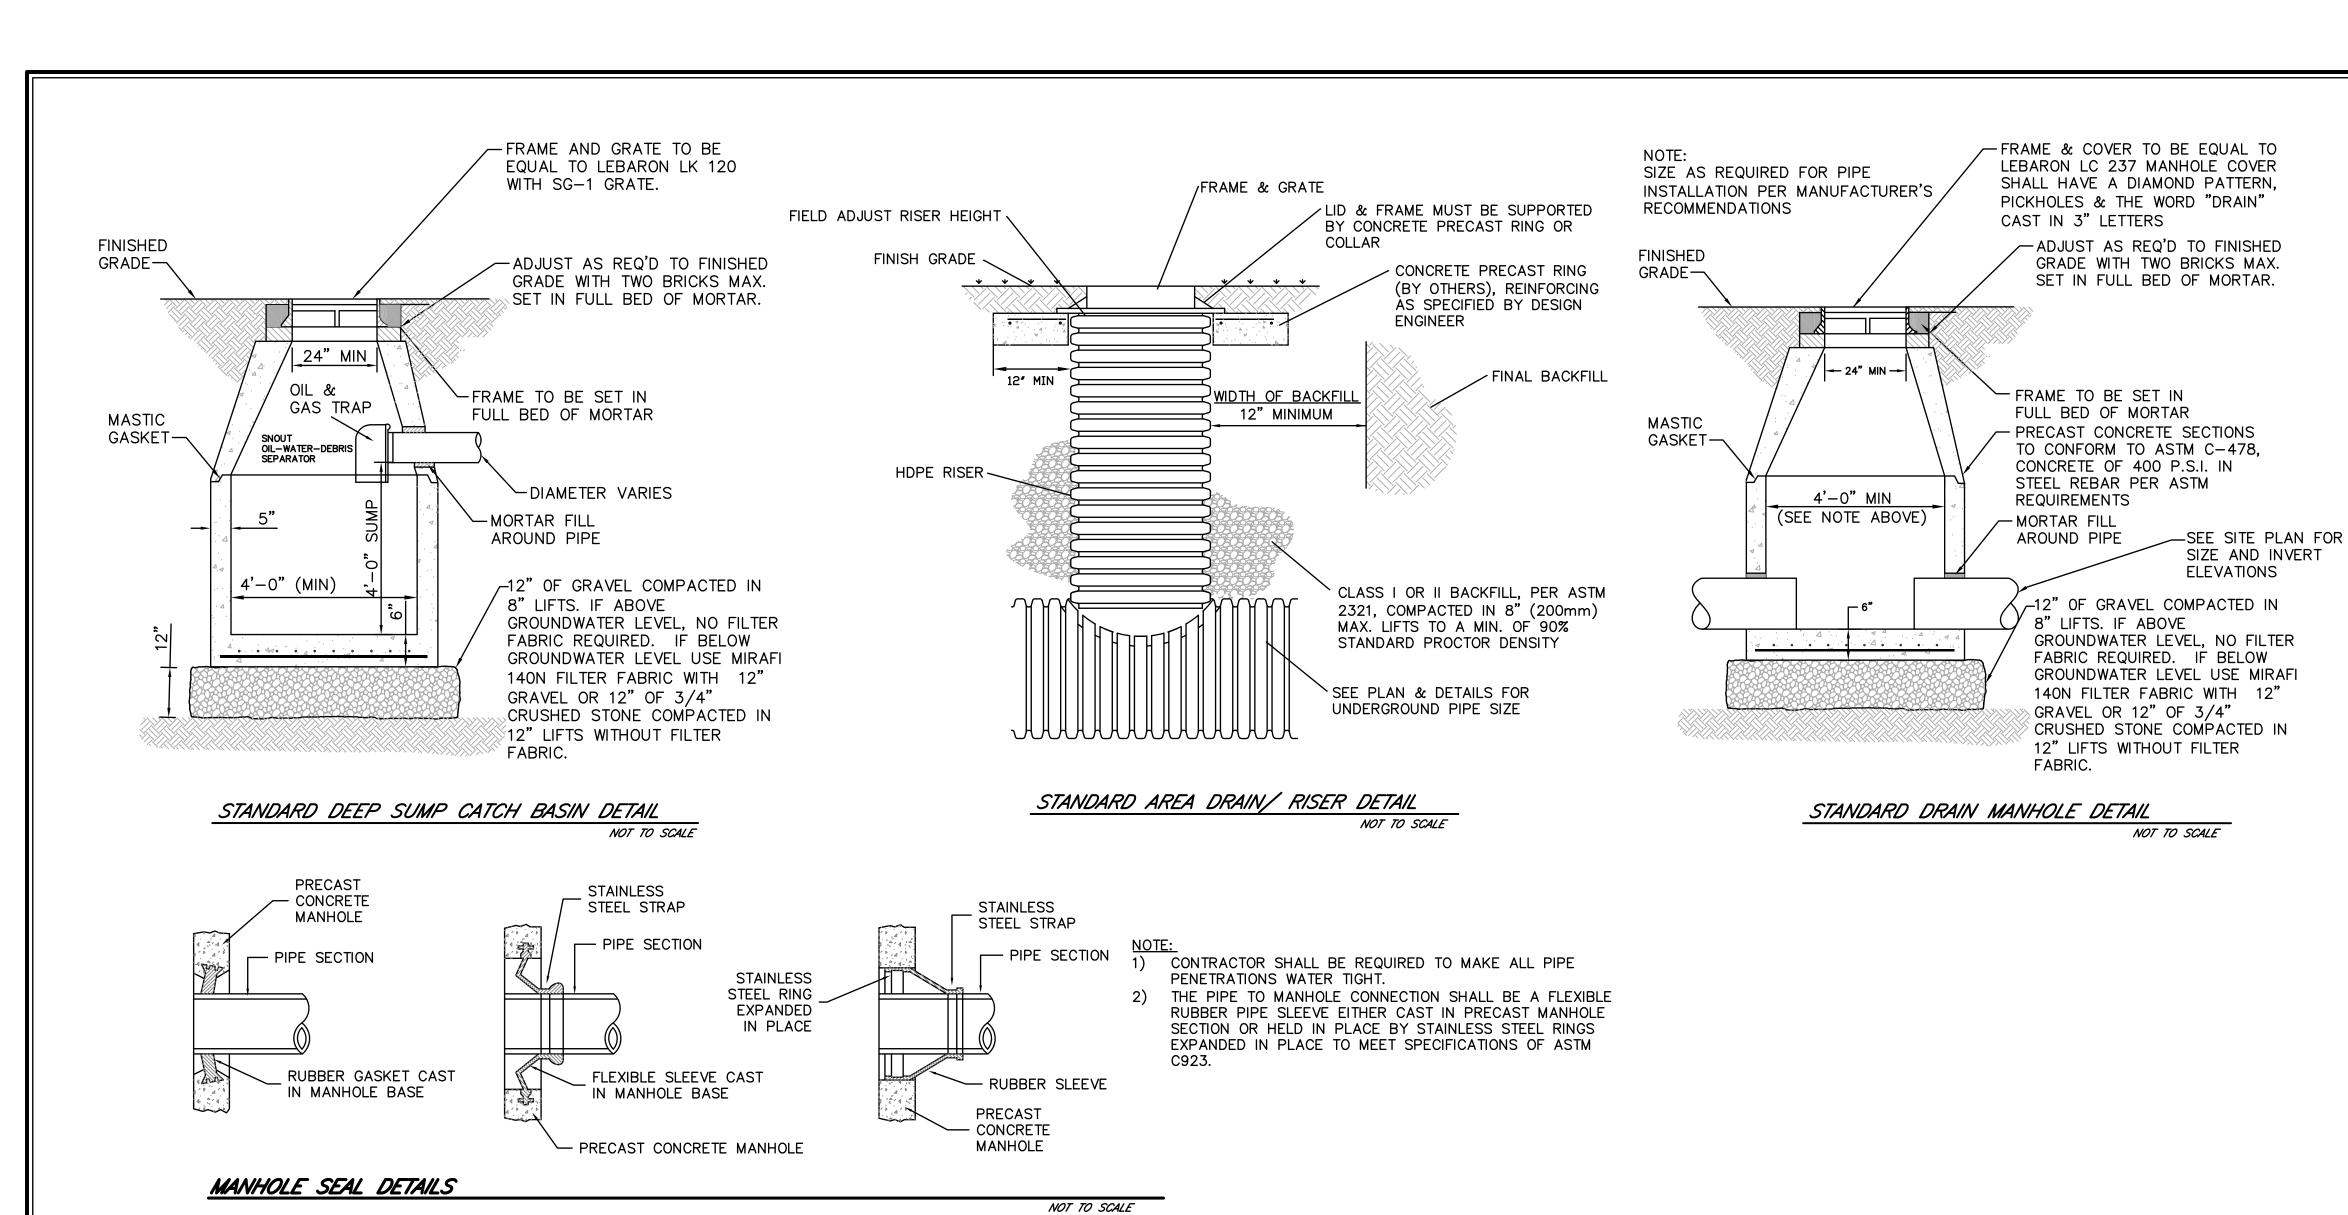

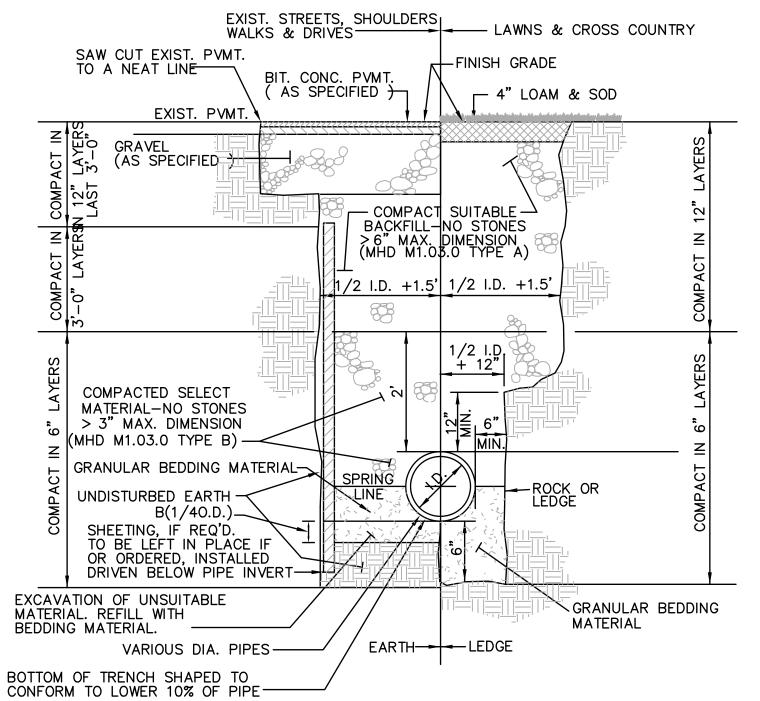

TYPICAL BEDDING DIMENSIONS PIPE MATERIAL - PVC (SDR 35)			
I.D.	O.D.	B(1/4 0.D.)	
4"	4.215"	1.05"	
6"	6.275"	1.57"	
8"	8.400"	2.10"	

1. GRANULAR BEDDING MATERIAL SHALL CONSIST OF 3/4" CRUSHED STONE (MHD M2.01.4) OR COMPACTED GRAVEL BORROW (MHD M1.03.0 TYPE C)

2. TRENCH BEDDING & BACKFILL FOR SANITARY SEWERS SHALL BE CLASS B AS DEFINED BY WPCF-MOPQ, AS SHOWN HEREIN.

TYPICAL DRAINAGE TRENCH DETAIL NOT TO SCALE

		RIM = 801.00 FT	
OUTLET (12"ø HDPE)			
	Ø48" INLET INLET AS REQUIRED	TOP OF OVERFLOW WEIR TOP OF LOW FLOW WEIR OUTLET INV. = 795.10 FT BOTTOM OF PRETREATMENT AREA AS REQUIRED SEE DIMENSIONS & CAPACITIES TABLE	
PLAN		48"	
		OMPACTED 3/4" CRUSHED STONE	

PROFILE

HYDROWORKS HS4i DETAIL

NOT TO SCALE

LEICESTER PLANNING BOARD SITE PLAN APPROVAL

DATE:

DETAIL SHEET

(508) 248-2005 (508) 248-4887

DRAWN BY: 2/14/2020 CHK BY: AS NOTED PROJ. NO. 151-2058-K

C-7